Mann Hall Renovation

09 AUGUST 2024 PW PROJECT #820937.001

VOLUME 1


DESIGN DEVELOPMENT DOCUMENTS

2501 Stinson Dr Raleigh, NC 27607

Perkins&Will Perkins&Will

OWNER	ARCHITECT	INTERIOR DESIGN	STRUCTURAL	MEP	CIVIL	CONTRACTOR	AUDIO/VISUAL	LIGHTING	SUSTAINABILITY	STATE CONSTRUCTION OFFICE
Facilities Division Design & Construction Administrative Services Building III 411 277	1 W. Chapel Hill Street Suite 200, Durham, NC 701	Perkins&Will 411 W. Chapel Hill Street Suite 200, Durham, NC 27701 (919) 433-5300 (TEL)	Lynch Mykins Structural Engineers 301 N. West Street Suite 105, Raleigh, NC 27603 (919) 782-1833 (TEL)		NV5 Engineers and Consultants 3300 Regency Parkway Suite 100, Cary, NC 27518 (919) 836-4800 (TEL)	6210 Ardrey Kell Road Suite 400, Charlotte, NC	4905 Professional Court, Raleigh, NC 27609 (919) 876-9799 (TEL)	Available Light 5700 Six Forks Road, Suite 203, Raleigh, NC 27609 (212) 977-2611 (TEL)	Ecoimpact Consulting 8022 Providence Road Suite 500, Charlotte, NC 28277 (212) 977-2611 (TEL)	301 N Wilmington St # 450, Raleigh, NC 27601 (919) 807-4100 (TEL)

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DEMO 01-GEI	NEDAL	}	
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G01-01A	CODE COMPLIANCE DATA - DEMOLITION	04/17/2024	10/28/2024
G01-02A	SITE LOGISTICS PLAN		10/28/2024
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A00-01A	REFERENCE SHEET	04/17/2024	10/28/2024
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P04-00	STANDARDS, SYMBOLS & ABBREVIATIONS - DEMO	04/17/2024	10/28/2024
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H04-01	DEMOLITION PLAN - FLOOR 01	04/17/2024	10/28/2024
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H04-05	DEMOLITION PLAN - ROOF	04/17/2024	10/28/2024
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DEMO_09 - EL E04-00	STANDARDS, SYMBOLS & ABBREVIATIONS - DEMO	04/17/2024	10/28/2024
E04-00 E04-01E	DEMOLITION PLAN - FLOOR 01 - POWER	04/17/2024	10/28/2024
E04-01L	DEMOLITION PLAN - FLOOR 01 - POWER	04/17/2024	10/28/2024
E04-01L E04-02	DEMOLITION PLAN - FLOOR 01 - LIGHTING  DEMOLITION PLAN - FLOOR 02	04/17/2024	10/28/2024
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E04-03	DEMOLITION PLAN - FLOOR 03	04/17/2024	10/28/2024
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PROC_01-GEN			
G00-00B	COVER SHEET AND INDEX OF DRAWINGS Copy 1	04/17/2024	10/28/2024
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PROC 04-ARC	CHITECTURAL		
A00-01B	REFERENCE SHEET	04/17/2024	10/28/2024
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Charlotte, NC 28203 t 704.972.5600 f 704.972.5601 www.perkinswill.com

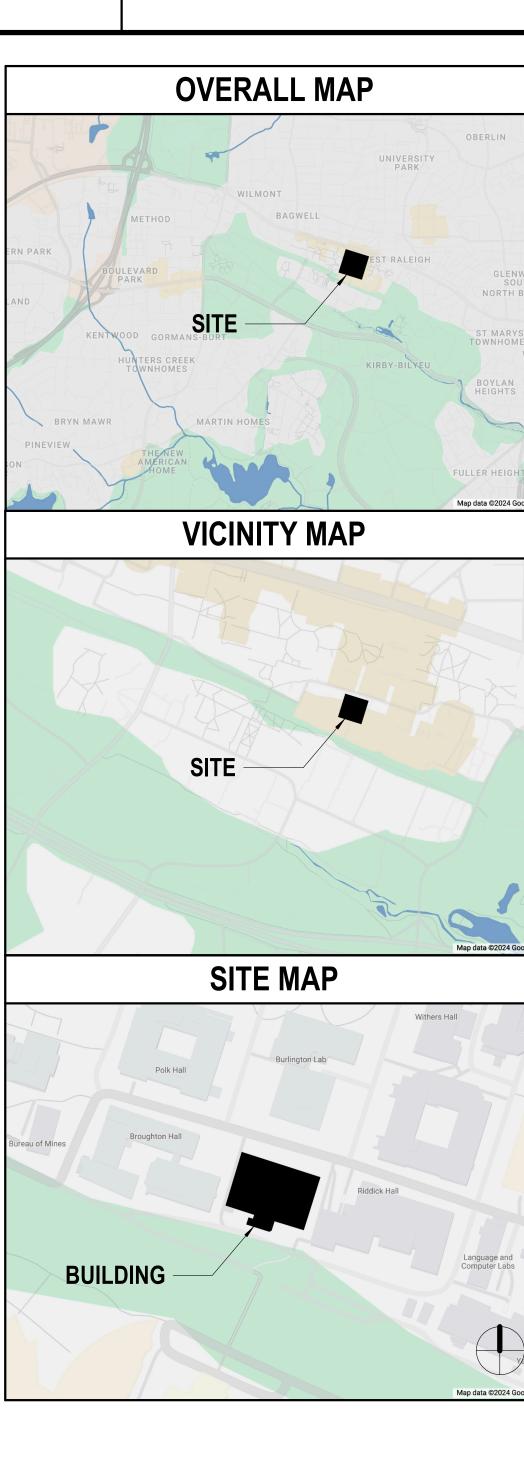CONSULTANTS


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Holder Construction Group

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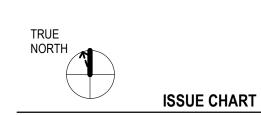


Mann Hall Renovation STATE ID #22-24500-02B NCSU PROJECT # 202220021



**North Carolina State** Facilities Division Design & Construction
Administrative Services Building III 2601 Wolf Village Way, Suite 331

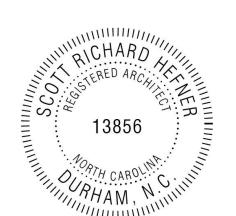Raleigh, NC 27695



Appro	<del></del>	Approve		
Check	red	Checker		
Drawr	1	Author		
Job N	umber 82	20937.001		
MARK	ISSUE	DATE		
1	ISSUE FOR BID - DEMO	4/17/2024		
3	ISSUE FOR BID - DEMO REV 1	10/28/2024		

**COVER SHEET AND INDEX OF DRAWINGS** 





#### 2018 APPENDIX B BUILDING CODE SUMMARY FOR ALL COMMERCIAL PROJECTS

(EXCEPT 1 AND 2-FAMILY DWELLINGS AND TOWNHOUSES)

(Reproduce the following data on the building plans sheet 1 or 2)

#### PROJECT INFORMATION Name of Project: THIS IS NONSTRUCTURAL, INTERIOR SELECTIVE DEMOLITION WITHIN AN EXISTING ACADEMIC BUILDING ON NC STATE'S CAMPUS. THE FINAL STATE OF THE BUILDING AFTER COMPLETION OF THIS PHASE WILL INCLUDE NO OCCUPIABLE SPACE. THE NEXT PHASE WILL INCLUDE PLANS CONTACTS DESIGNER E-MAIL Architectura scott.hefner@perkinswill.com 919-858-1888 michael.allen@nv5.com SALAS O'BRIEN SALAS O'BRIEN SALAS O'BRIEN justin.sarfin@salasobrien.com SALAS O'BRIEN adam.spach@salasobrien.com SALAS O'BRIEN Structural Retaining Walls >5' High Other ("Other" should include firms and individuals such as truss, precast, pre-engineered, interior designers, etc.)

#### **BUILDING CODE**

**2018 NC BUILDING CODE:** □ New Building □ Addition □ Renovation □ First Time Interior Completion ☐ Shell/Core - Contact the local inspection jurisdiction for possible additional procedures & requirements

☐ Phased Construction - Shell/Core - Contact the local inspection jurisdiction for possible additional procedures & requirements

2018 NC EXISTING BUILDING CODE: ☐ N/A ☐ Prescriptive ☐ Repair ☐ Chapter 14 ☐ Alteration Level I ☐ Alteration Level II ■ Alteration Level III ☐ Historic Property ☐ Change of Use CONSTRUCTED: (date) 1964 CURRENT OCCUPANCY(S): (Ch. 3)

RENOVATED: (date) PROPOSED OCCUPANCY(S): (Ch. 3)

☐ II-A

OCCUPANCY CATEGORY (Table 1604.5): Current: 

N/A 

I 

II 

IV Proposed: □ N/A □ I ■ II □ III □ IV

□ I-A

#### BASIC BUILDING DATA ☐ III-A □ IV

□ N/A □ NFPA 13 □ NFPA 13R □ NFPA 13D

		<b>Gross Building Area Table</b>			
FLOOR	EXISTING (SQ FT)	RENOVATED (SQ FT)	NEW (SQ FT)	SUB-TOTAL	
FLOOR 4	18,646	18,646	-	18,646	
FLOOR 3	18,646	18,646		18,646	
FLOOR 2	16,941	16,941		16,941	
FLOOR 1	23,291	23,291		23,291	
TOTAL	77.524	77.524		77.524	

		ALLO	<b>VABLE AREA</b>			
Primary Occupancies:						
Assembly	□ A-1	□ A-2	□ A-3	□ A-4	□ A-5	
Business						
Educational						
Factory	☐ F-1 Moderate	☐ F-2 Low				
Hazardous	☐ H-1 Detonate	☐ H-2 Deflagrate	☐ H-3 Combust	☐ H-4 Health	☐ H-5 HPM	
Institutional	□ I-1	□ I-2	□ I-3	□ I-4		
	I-3 Condition	□ 1	□ 2	□ 3	□ 4	□ 5
Mercantile						
Residential	□ R-1	□ R-2	□ R-3	□ R-4		
Storage	☐ S-1 Moderate	☐ S-2 Low	☐ High-piled			
Storage (Parking	Garage) $\square$ Open	☐ Enclosed	☐ Repair			

Accessory Occupancy Classification(s) ____N/A - DEMOLITION ONLY Incidental Uses (Table 509):

 □ 402
 □ 403
 □ 404
 □ 405
 □ 406
 □ 407
 □ 408
 □ 409
 □ 410
 □ 411
 □ 412

  $\square$  424  $\square$  425  $\square$  426  $\square$  427

Special Provisions (Ch 5 - List Code Sections):

Utility and Miscellaneous

■ No ☐ Yes Separation: _____ Hr.

☐ Yes ☐ No ☐ Non-Separated Use (508.3) ☐ Separated Use (508.4) See below for area calculations for each story, the area of the occupancy shall be such that the sum of the ratios of the actual floor area of each use divided by the allowable floor area for each use shall not exceed 1.

> Actual Area of Occupancy B Actual Area of Occupancy A Allowable Area of Occupancy A Allowable Area of Occupancy B

STORY NO.	DESCRIPTION AND USE	(A) BLDG. AREA PER STORY (ACTUAL)	(B) TABLE 506.2 ⁴ AREA	(C) AREA FOR FRONTAGE INCREASE ^{1,5}	(D) ALLOWABLE AREA PER STORY OR UNLIMITED ²
4	BUSINESS / UNOCCUPIED	18,646 SF	23,000 SF	14,375 SF	37,375 SF
3	BUSINESS / UNOCCUPIED	18,646 SF	23,000 SF	14,375 SF	37,375 SF
2	BUSINESS / UNOCCUPIED	16,941 SF	23,000 SF	14,375 SF	37,375 SF
1	BUSINESS / UNOCCUPIED	23,291 SF	23,000 SF	14,375 SF	37,375 SF

- 1 Frontage area increases from Section 506.2 are computed thus:
- a. Perimeter which fronts a public way or open space having 20 feet minimum width =  $\frac{610}{}$  (F)
- b. Total Building Perimeter = ____610 (P) c. Ratio (F/P) = _____(F/P)
- d. W = Minimum width of public way =  $\frac{25}{}$  (W)
- e. Percentage of frontage increase  $I_f = [F/P 0.25] \times W/30 = \frac{62.5}{}$  (%) 2 Unlimited area applicable under conditions of Section 507.
- 3 Maximum Building Area = total number of stories in the building x D (maximum 3 stories) (506.2).
- ⁴ The maximum area of open parking garages must comply with Table 406.5.4. The maximum area of air traffic control towers must comply with Table 412.3.1. ⁵ Frontage increase is based on the unsprinklered area value in Table 506.2

	ALLOWABLE	SHOWN ON PLANS	CODE REFERENCE
Building Height in Feet (Table 504.3)	55 FT	EXISTING TO REMAIN - 53 FT	
Building Height in Stories (Table 504.4)	3 STORIES	EXISTING TO REMAIN - 3 STORIES	

**ALLOWABLE HEIGHT** 

rovide code reference if the "Shown or	n Plans" quantity is not based on Table 504.3 or	504.4.
TO VIGE CODE TETETETICE II THE SHOWIT OF	11 lans quantity is not based on Table 304.3 of	JU4.4.

#### FIRE PROTECTION REQUIREMENTS


BUILDING ELEMENT	FIRE SEPARATION DISTANCE (FEET)	REQ'D	PROVIDED (W/* REDUCTION)	DETAIL # AND SHEET #	DESIGN# FOR RATED ASSEMBLY	SHEET # FOR RATED PENETRATION	SHEET # FOR RATED JOINTS
Structural Frame, including columns, girders, trusses							
Bearing Walls							
Exterior	-	0	EXISTING TO REMAIN				
North	98 FT	0	EXISTING TO REMAIN				
East	25 FT	0	EXISTING TO REMAIN				
West	27 FT	0	EXISTING TO REMAIN				
South	137 FT	0	EXISTING TO REMAIN				
Interior	-	0	EXISTING TO REMAIN				
Nonbearing walls and Partitions							
Exterior walls	-	0	EXISTING TO REMAIN				
North	-	0	EXISTING TO REMAIN				
East	-	0	EXISTING TO REMAIN				
West	-	0	EXISTING TO REMAIN				
South	-	0	EXISTING TO REMAIN				
Interior walls and partitions	-	0					
Floor Construction including supporting beams and joists	-	0	EXISTING TO REMAIN				
Floor / Ceiling Assembly	-	0	EXISTING TO REMAIN				
Columns Supporting Floors	-	0	EXISTING TO REMAIN				
Roof Construction including supporting beams and joists	-	0	EXISTING TO REMAIN				
Roof Ceiling Assembly	-	0	EXISTING TO REMAIN				
Columns Supporting Roof	-	0	EXISTING TO REMAIN				
Shaft Enclosures - Exit	-	2	EXISTING TO REMAIN				
Shaft Enclosures - Other	-	2					
Corridor Separation	-	N/A					
Occupancy / Fire Barrier Separation	-	N/A					
Party/Fire Wall Separation	-	N/A					
Smoke Barrier Separation	-	N/A					
Smoke Partition	-	N/A					
Tenant / Dwelling Unit / Sleeping Unit Separation	-	N/A					
Incidental Use Separation	-	N/A					

* Indicate section number permitting reduction

	OPENING CALCULATIONS	NO CHANGE TO EXISTING. CHANGES TO OCCUR IN NEXT SUBMITTAL	
FIRE SEPARATION DISTANCE (FEET) FROM PROPERTY LINES	DEGREE OF OPENINGS PROTECTION (TABLE 705.8)	ALLOWABLE AREA (%)	ACTUAL SHOWN ON PLANS (%)
NORTH & SOUTH - GREATER THAN 30'	UNPROTECTED, NONSPRINKLERED	UNLIMITED	
EAST - 25'	UNPROTECTED, NONSPRINKLERED	70%	35% (EXISTING TO REMAIN)

UNPROTECTED, NONSPRINKLERED

37% (EXISTING TO REMAIN)

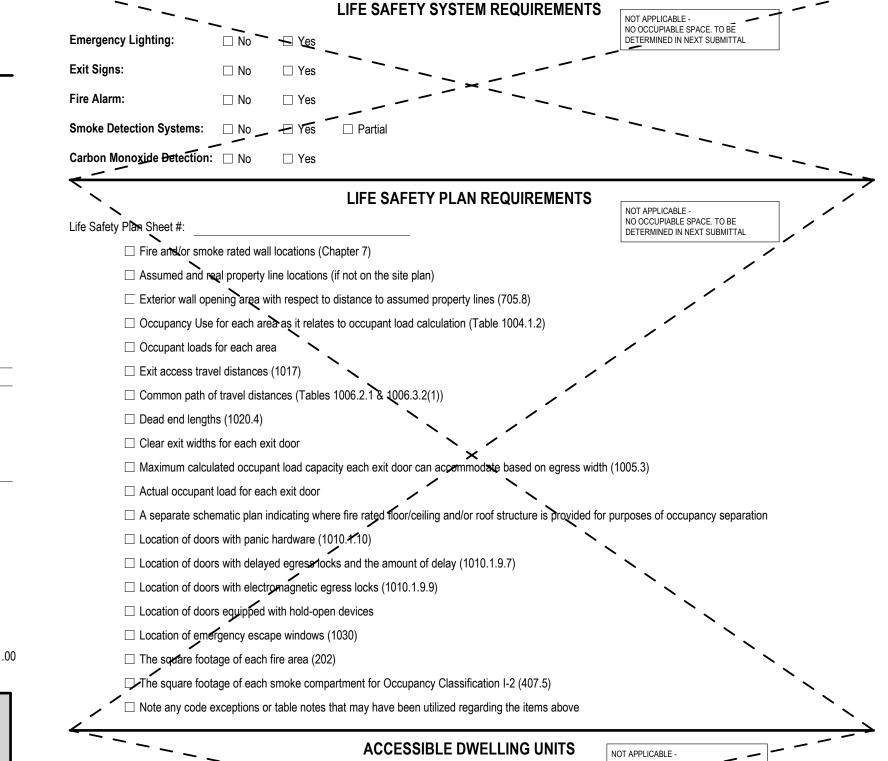

	_			(SECTION 110	7) 	B OCCUPANCY ONLY	
TOTAL UNITS	ACCESSIBLE UNITS REQUIRED	ACCESSIBLE UNITS PROVIDED	TYPE A UNITS / REQUIRED	YPEA UNITS PROVIDED	TYPE B  JUNITS  REQUIRED	TYPE B UNITS — PROVIDED	TOTAL ACCESSIBLE UNITS PROVIDED
						/	, , , , , , , , , , , , , , , , , , , ,
	`			ESSIBLE PAR (SECTION 110	_	NOT APPLICABLE - TO BE DETERMINED IN NE	EXT SUBMITTAL

` ` `			(SECTION 1106)	TO BE D	ETERMINED IN NEXT SUBMITTAL					
	TOTAL # OF PA	RKING SPACES	# OF A	CCESSIBLE SPACES P	ROVIDED	TOTAL #				
LOT OR	DECUMPED	2201/1252	REGULAR WITH 5'	VAN SPA	VAN SPACES WITH					
PARKING AREA	REQUIRED	PROVIDED	ACCESS AISLE	132" ACCESS AISLE	" ACCESS AISLE 8' ACCESS AISLE					
		` \								
				/						
TOTAL				1						
			><							
	PLUMBING FIXTURE REQUIREMENTS  (TABLE 2002 1)  NOT APPLICABLE - NO OCCUPIABLE SPACE. TO BE									

				_		(TABLE	2902.1)	` \	DETERMINED IN	NEXT SUBMITTAL	
ι	JSE		WATERCLO	DSETS	URINALS		LAVATORIES	, ,	SHOWERS	DRINKING	FOUNTAINS
		MALE	FEMALE	UNISEX		MALE	FEMALE	UNISEX	<b>⊀</b> TUBS	REGULAR	ACCESSIBLE
SPACE	EXIST'G								Ì		
	NEW /									``\	
	-REQ'D										
				-						-	

#### **SPECIAL APPROVALS**

**Special Approval:** (Local Jurisdiction, Department of Insurance, OSC, DPI, DHHS, etc., describe below)

#### **ENERGY SUMMARY**

**ENERGY REQUIREMENTS** The following data shall be considered minimum and any special attribute required to meet the energy code shall also be provided. Each Designer shall furnish the required portions of the project information for the plan data sheet. If performance method, state the annual energy cost for the standard reference design vs annual energy cost for

**Existing building envelope complies with code:** 

No 

Yes (The remainder of this section is not applicable)

PER NCEBC 908, ALTERATIONS TO EXISTING BUILDINGS ARE NOT REQUIRED TO COMPLY WITH ENERGY REQUIREMENTS. NO ENVELOPE MODIFICATIONS ARE PROPOSED IN THIS PHASE.

Method of Compliance: 

Energy Code - Performance Energy Code - Prescriptive ASHRAE 90.1 - Performance ASHRAE 90.1 - Prescriptive

Other - Performance (Specify source here) THERMAL ENVELOPE (Prescriptive method only) Roof/ceiling Assembly (each assembly)

Description of assembly: U-Value of total assembly: R-Value of insulation: Skylights in each assembly: U-Value of skylight: Total square footage of

skylights in each assembly: Exterior Walls (each assembly) Description of assembly: U-Value of total assembly R-Value of insulation: Openings (windows or doors with glazing)

Projection factor: Door R-Values: Walls below grade (each assembly) Description of assembly;


R-Value of insulation: Floors over unconditioned space (each assembly) Description of assembly:

U-Value of total assembly:

U-Value of assembly:

U-Value of total assembly: R-Value of insulation: Floors slab on grade

Description of assembly: U-Value of total assembly: R-Value of insulation: Horizontal/vertical requirement:

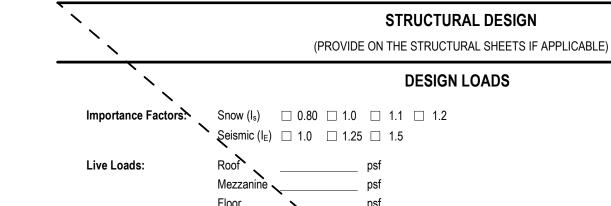

**Ground Snow Load:** Basic Wind Speed Exposure Category  $\square$  N/A  $\square$  B  $\searrow$  C  $\square$  D

> SEISMÌC DÉSIGN Seismic Design Category: ☐ N/A ☐ A ☐ B ☐ C Provide the following Seismic Design Parameters: Risk Category (Table 1604.5) □ N/A □ I ✓□ II □ III □ IV Spectral Response Acceleration: S_s______%g S₁______%g Site Classification (ASCE 7):  $\square$   $\nearrow$ /A  $\square$  A  $\square$  B  $\square$  C  $\square$  D  $\square$  E  $\square$  F Data Source: ✓ N/A ☐ Field Test ☐ Presumptive ☐ Historical Data

> > Architectural, Mechanical, Components anchored? ☐ N/A ☐ Yes ☐ No

Basic structural system: ☐ N/A ☐ Bearing Wall ☐ Building Frame ☐ Moment Frame ☐ Dual w Special Moment Frame ✓ Dual w/ Intermediate R/C or Special Steel ☐ Inverted Pendulum Analysis Procedure: ☐ N/A ☐ Simplified ☐ Equivalent Lateral Force ☐ Dynamic

MECHANICAL DESIGN

(PROVIDE ON THE MECHANICAL SHEETS IF APPLICABLE)

NO STRUCTURAL SCOPE IN THIS PHASE.

NO OCCUPIABLE SPACE PROPOSED IN

THIS PHASE. SEE MECHANICAL SHEETS.

NO OCCUPIABLE SPACE PROPOSED IN

THIS PHASE. SEE ELECTRICAL SHEETS.

Lateral Design Control: ☐ N/A ☐ Earthquake ☐ Wind Soil Bearing Capacities: 

N/A Field Test (Provide copy of test report) 

Presumptive Bearing Capacity _ Pile size, type, and capacity:

**MECHANICAL SYSTEMS, SERVICE SYSTEMS, & EQUIPMENT** Thermal zone: winter dry bulb: summer dry bulb: Interior design conditions: winter dry bulb: summer dry bulb: relative humidity: Building heating load:

Mechanical Spacing Conditioning System description of unit: heating efficiency: cooling efficiency: size category of unit: Size category. If oversized, state reason:

> List equipment efficiencies: **ELECTRICAL DESIGN ELECTRICAL SYSTEM & EQUIPMENT**

Method of Compliance: ☐ N/A ☐ Energy Code - Prescriptive ☐ Energy Code - Performance ☐ ASHRAE 90.1 Prescriptive ☐ ASHRAE 90.1 - Performance Lighting schedule (each fixture type) lamp type required in fixture number of lamps in fixture ballast type used in the fixture number of ballasts in fixture

total wattage per fixture total interior wattage specified vs. allowed (whole building of space by space) total exterior wattage specified vs. allowed Additional Efficiency Package Options (When using the 2018 NCECC; not required for ASHRAE 90.1)

C406.2 More Efficient HVAC Equipment Performa C406.3 Reduced Lighting Power Density C406 4 Enhanced Digital Lighting Controls C406.5 On-Site Renewable Energy

C406.6 Dedicated Outdoor Air System ☐ C406.7 Reduced Energy Use in Service Water Heating

#### Perkins&Will

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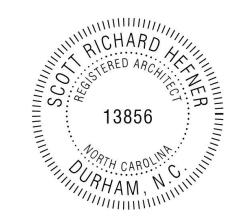
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**North Carolina State** University Facilities Division Design & Construction Administrative Services Building III 2601 Wolf Village Way, Suite 331 Raleigh, NC 27695



**ISSUE CHART** 

3 ISSUE FOR BID - DEMO REV 1 10/28/2024 1 ISSUE FOR BID - DEMO 4/17/2024 Job Number 820937.001 Author Checker


> **CODE COMPLIANCE DATA - DEMOLITION**

Approver

TITLE

SHEET NUMBER

G01-01A

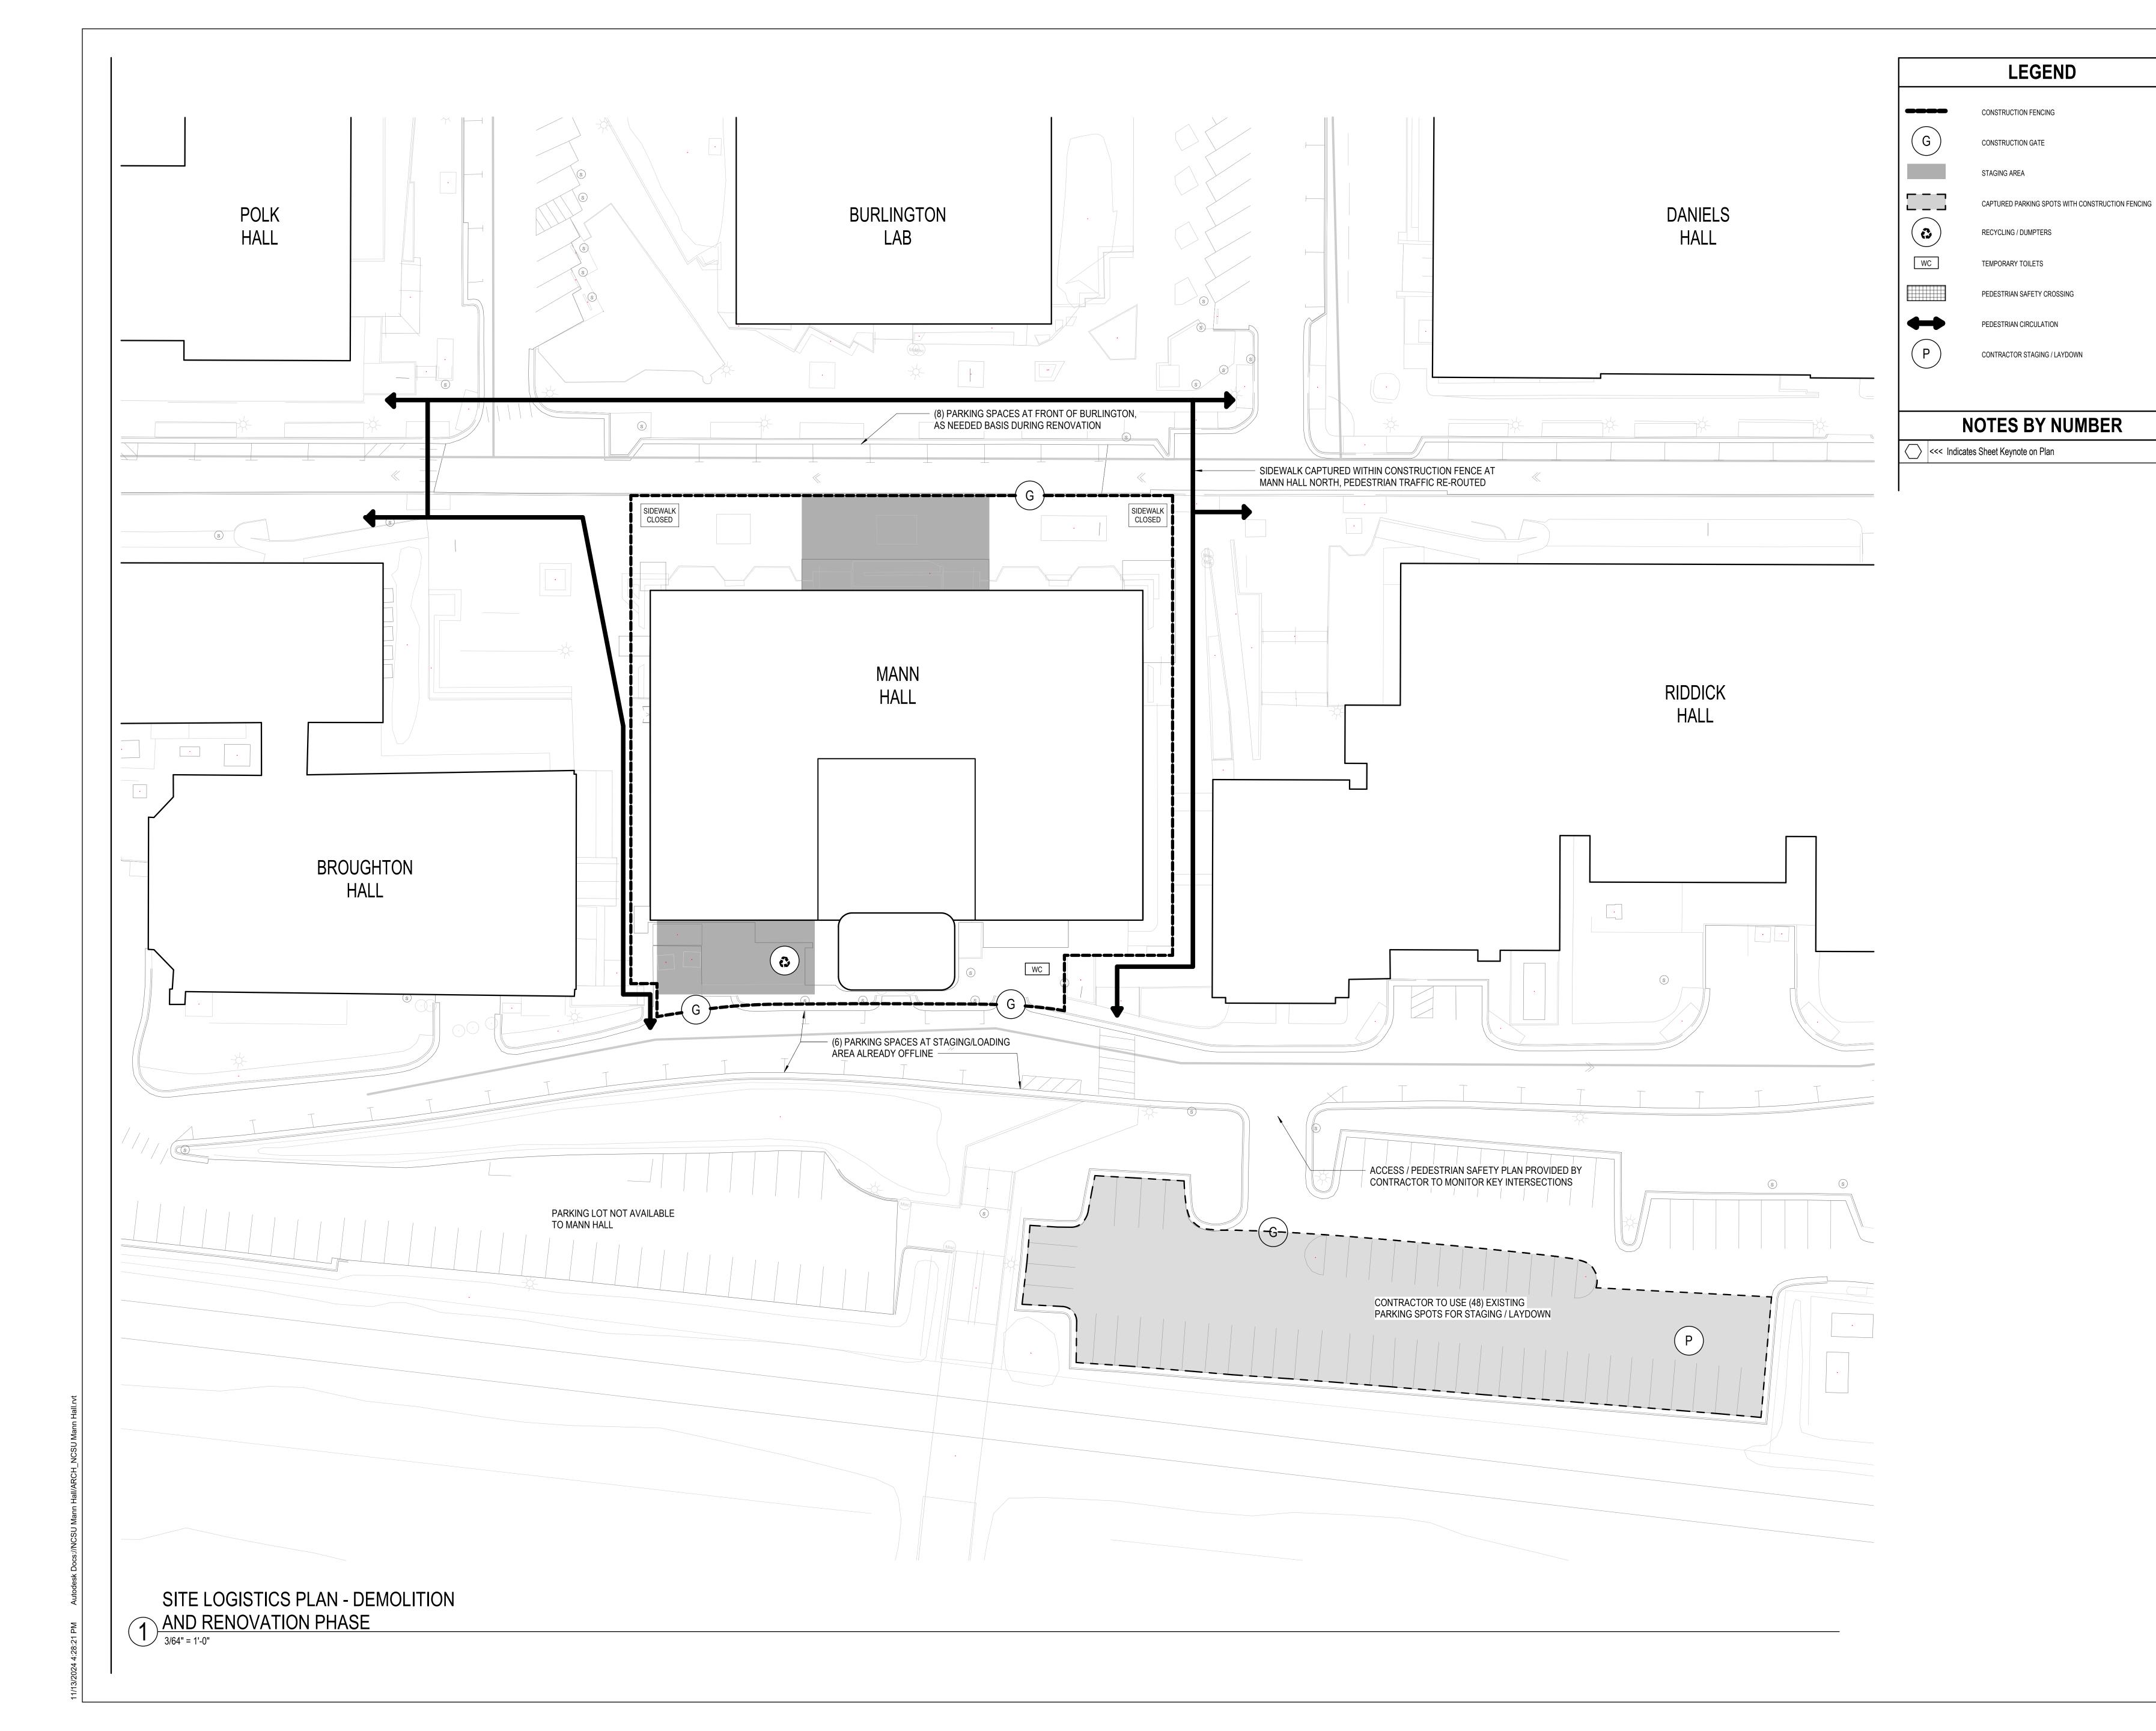

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NORTH CAROLING SWIJE CERT.NO. 50723

CHARLOTTE, NOTE, NOTE,



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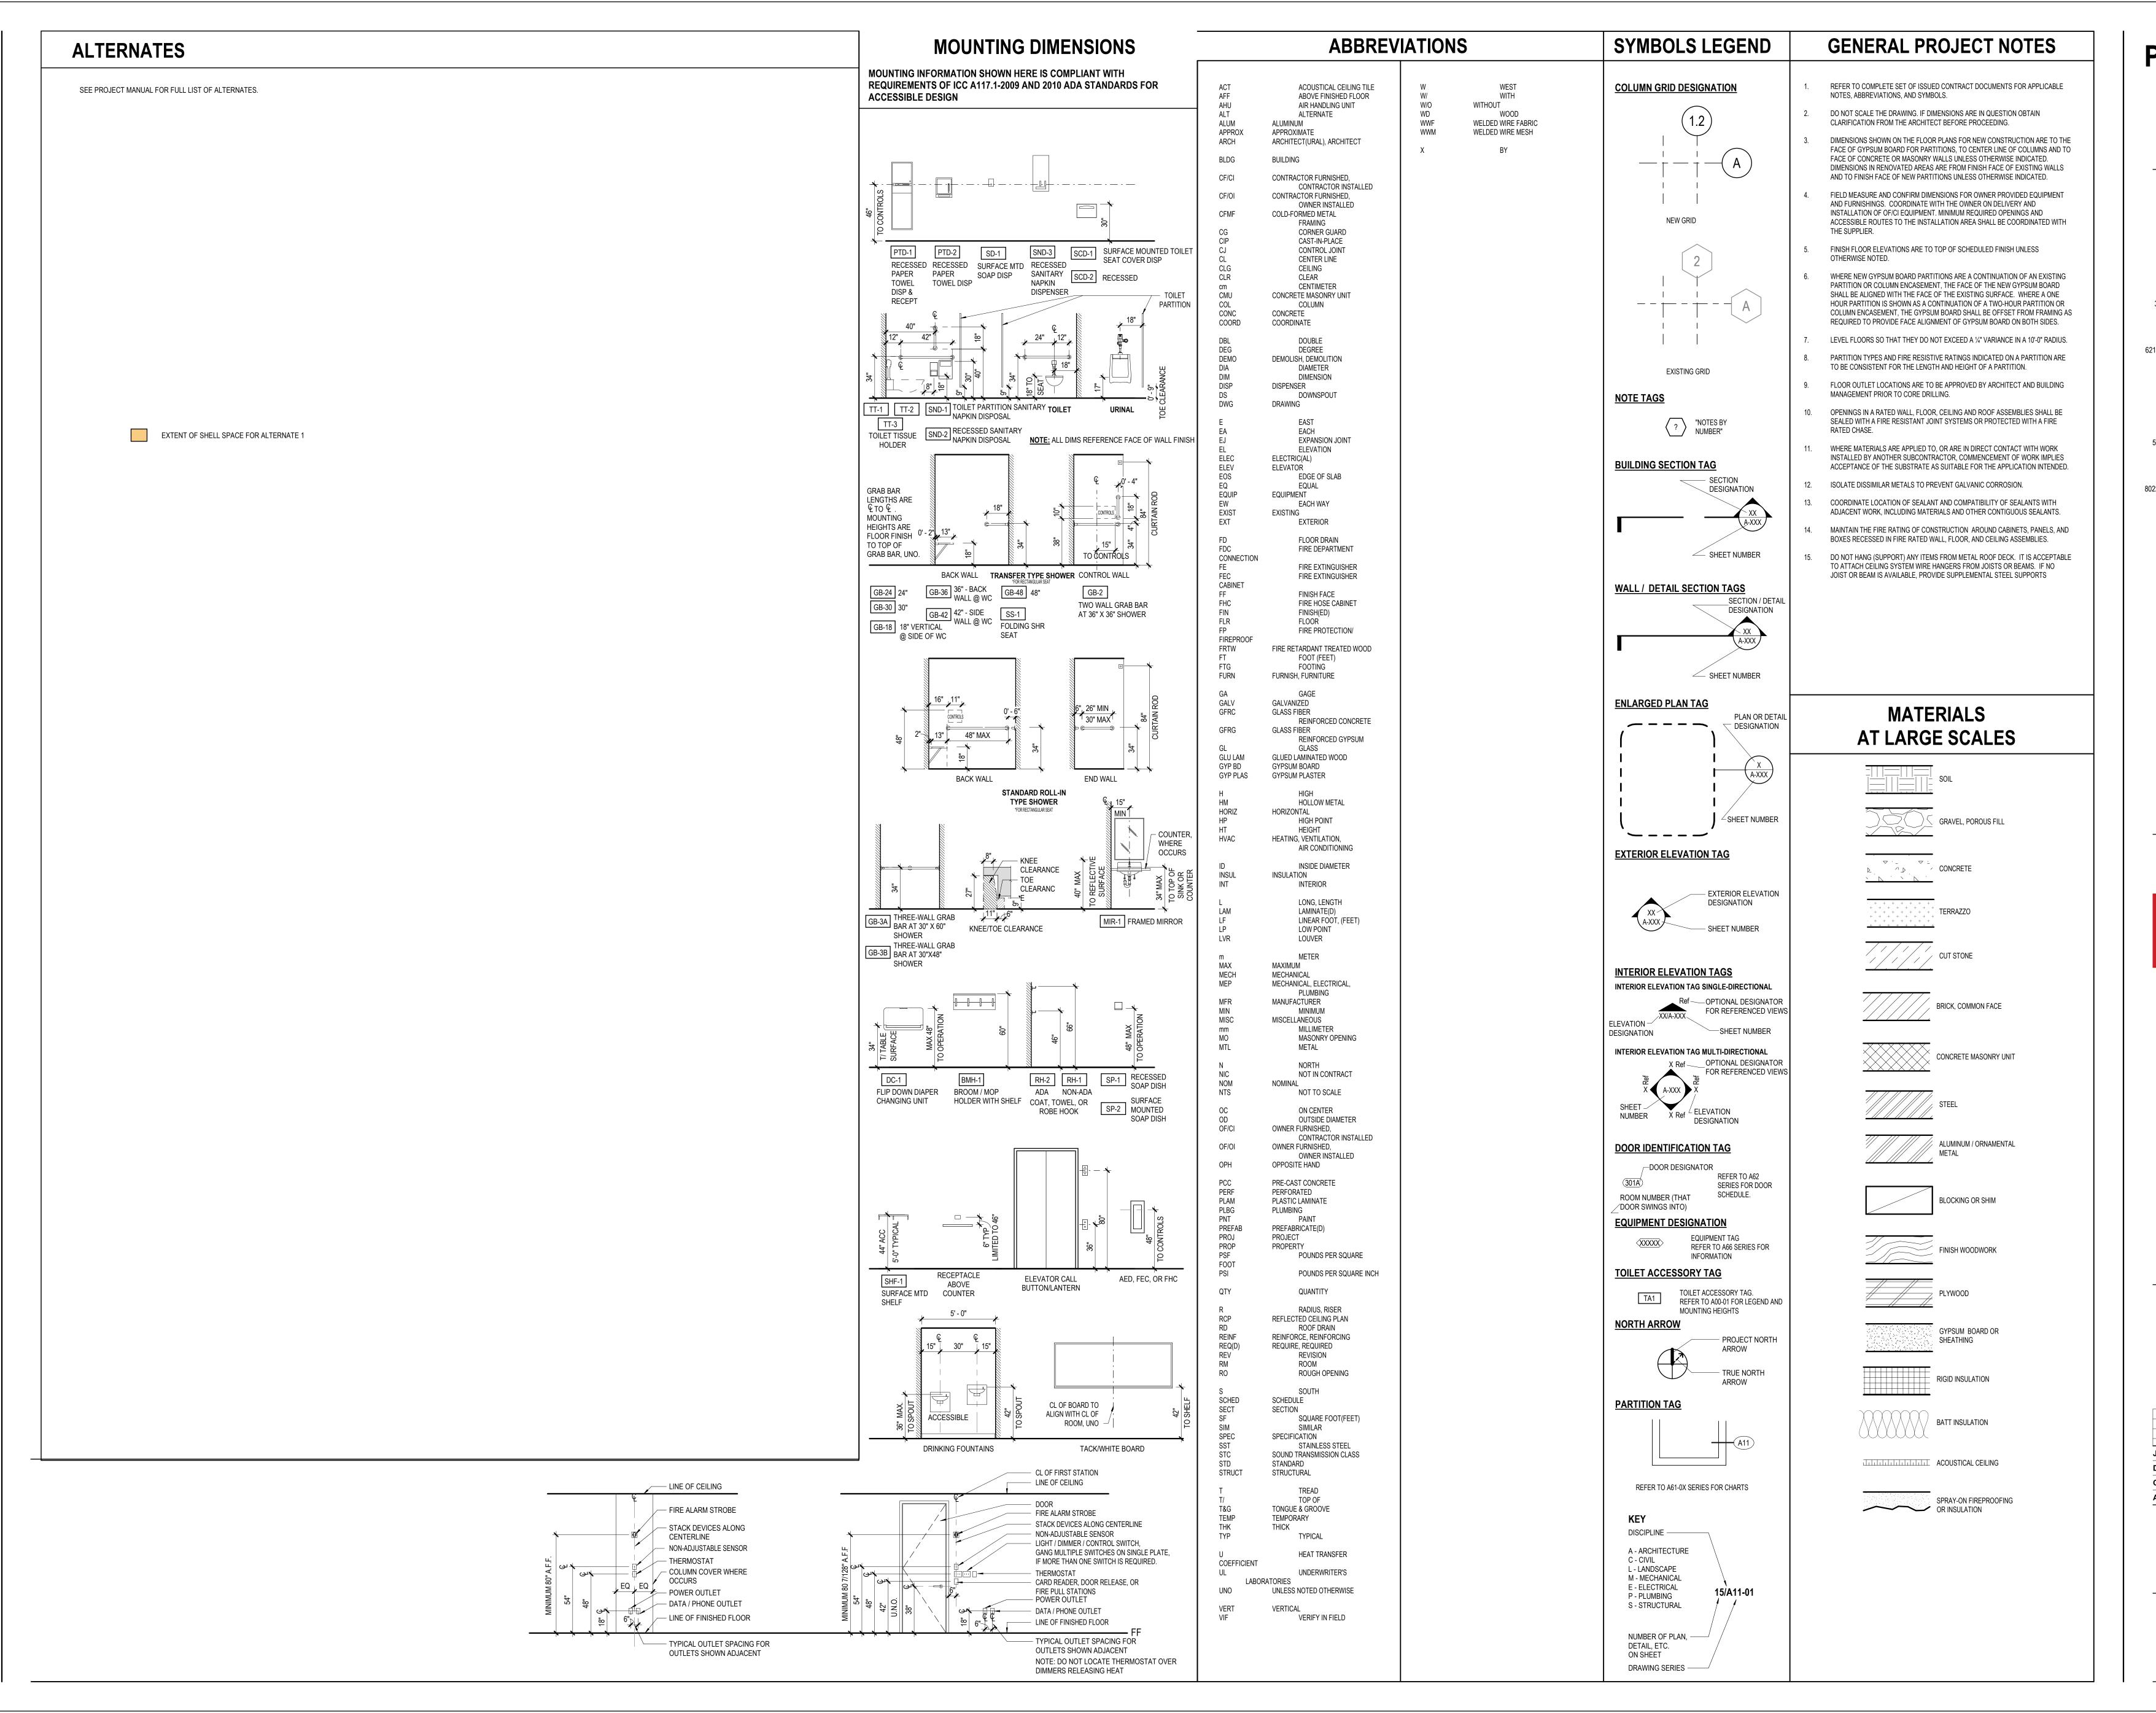
ISSUE CHART

	ISSUE FOR BID - DEMO REV 1	10/28/2024
RΚ	ISSUE	DATE
Number 82		0937.001
wn		Author
cked		Checker
ro	ved	Approver

SITE LOGISTICS PLAN

SHEET NUMBER

G01-02A



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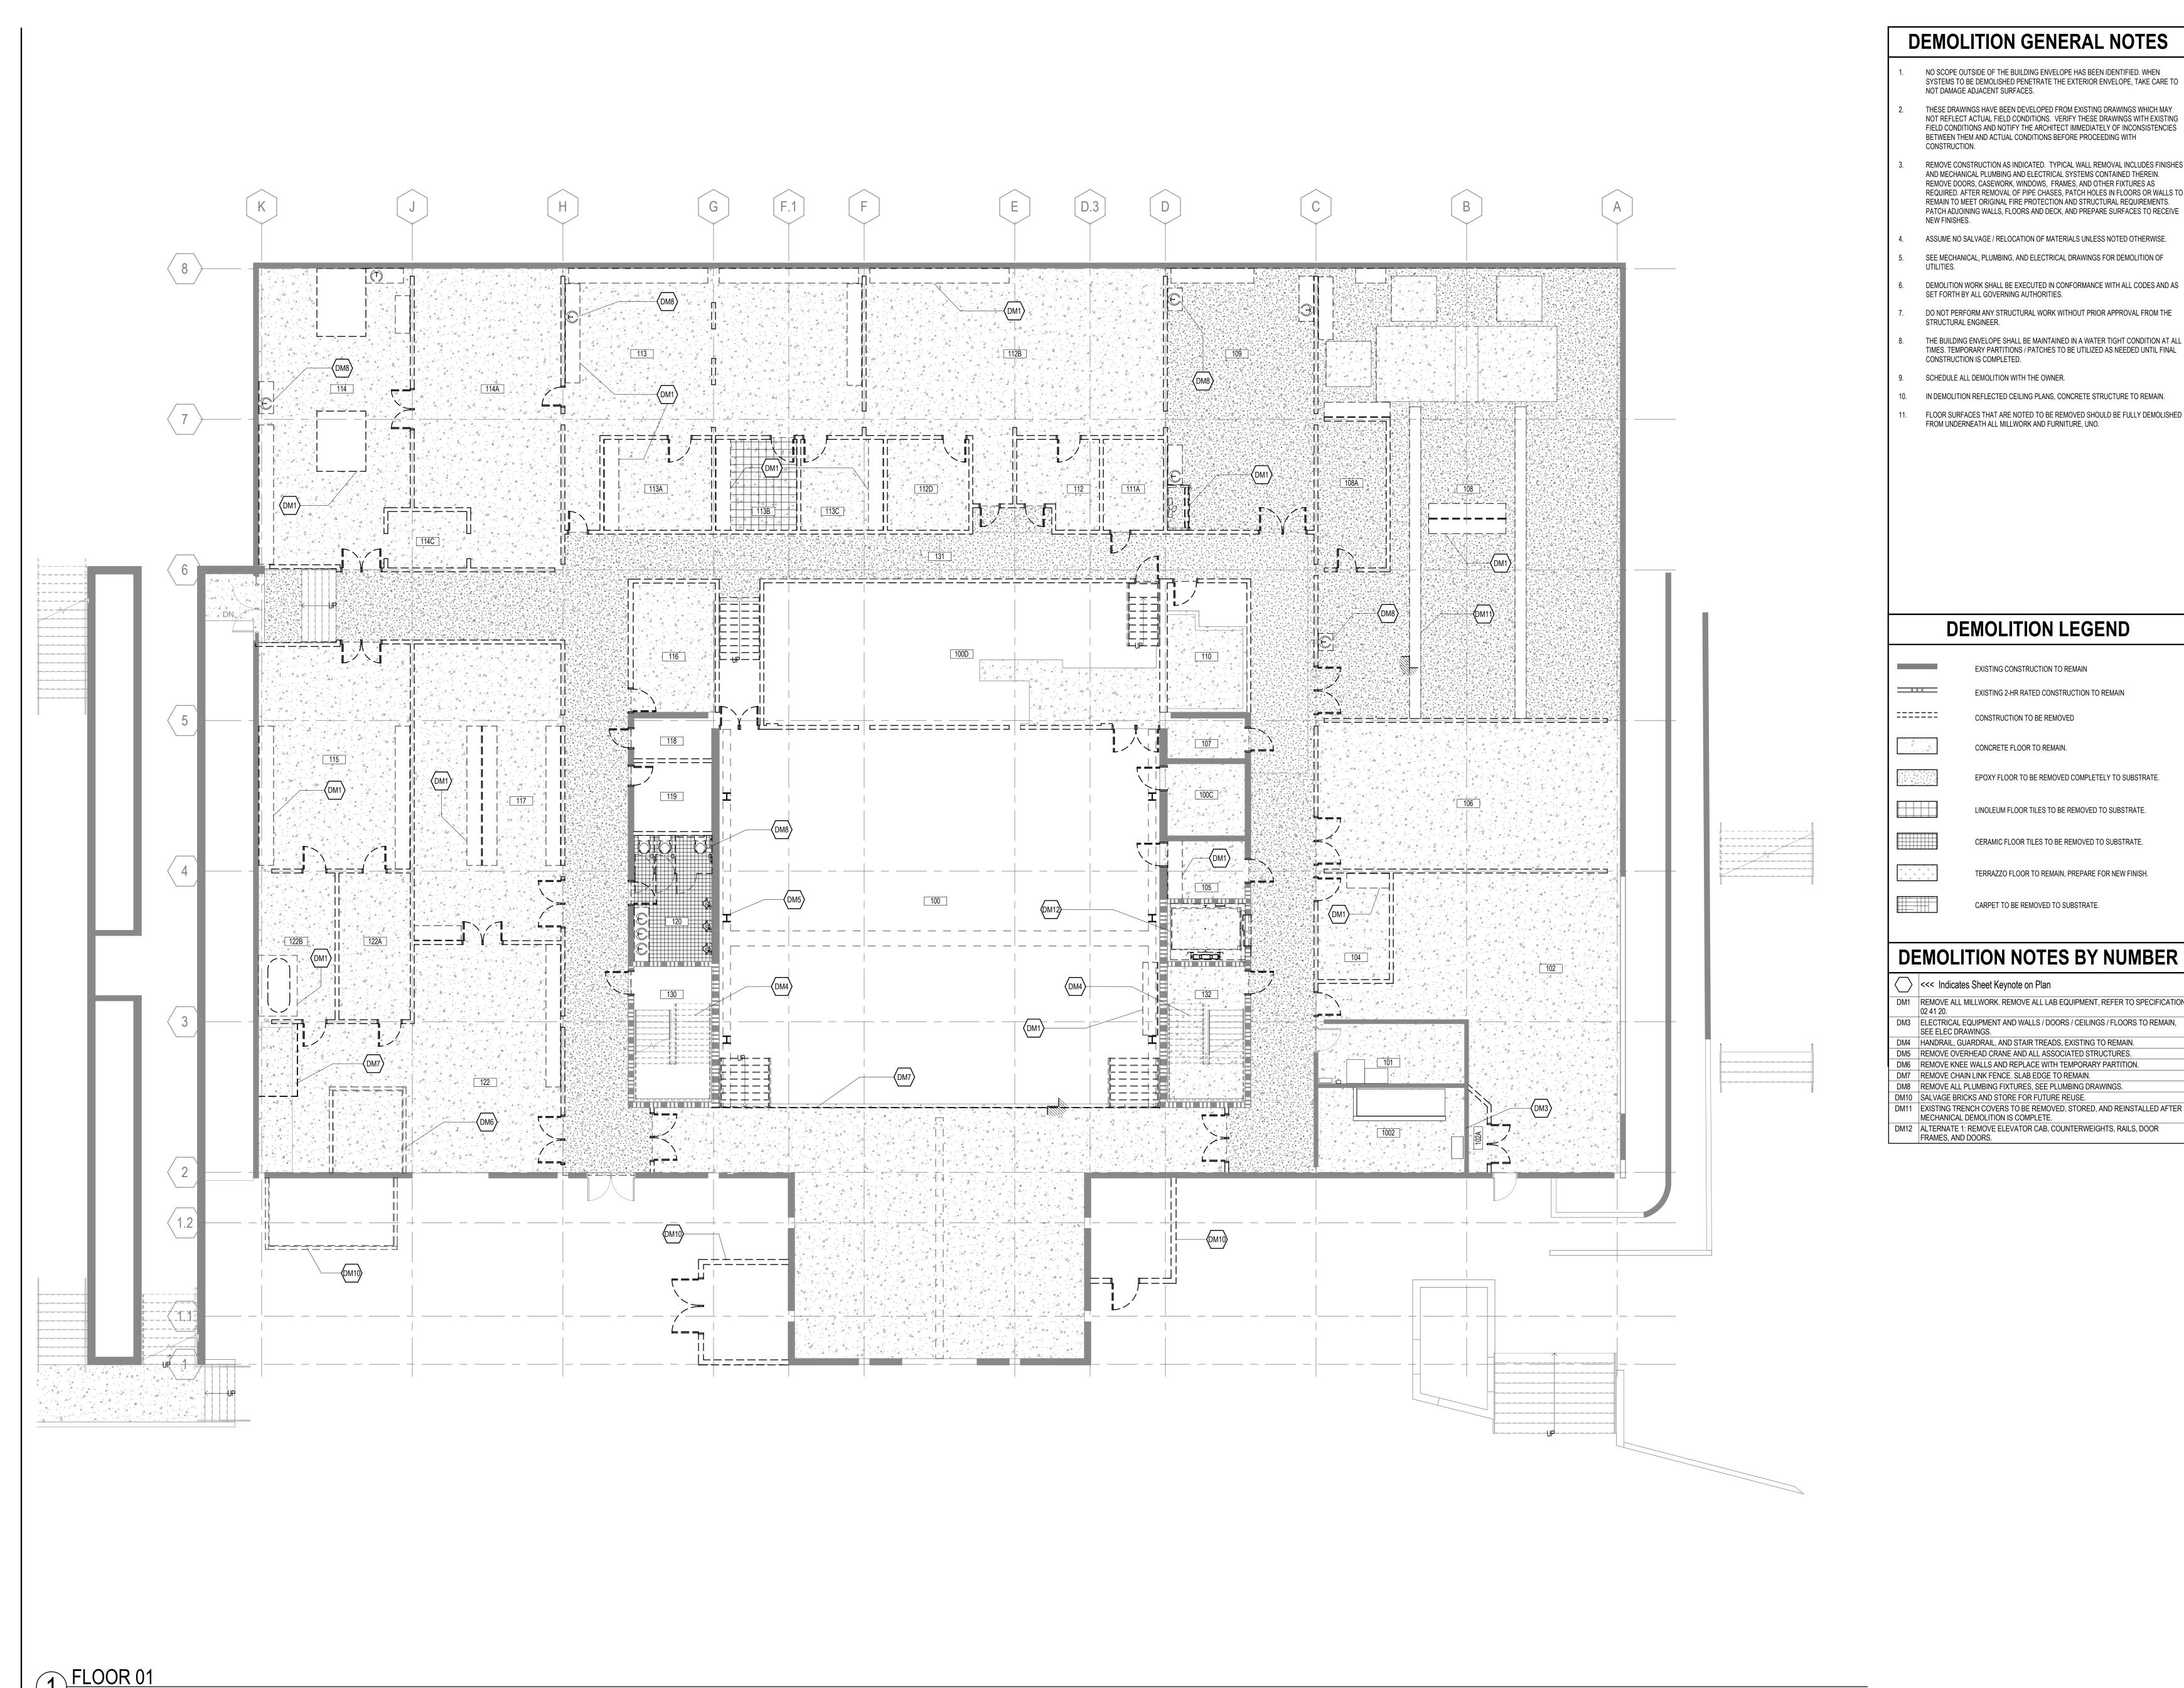
ISSUE FOR BID - DEMO REV 1 10/28/2024 DESIGN DEVELOPMENT 8/9/2024 ISSUE FOR BID - DEMO 4/17/2024 Job Number 820937.001 Author Checker Approver

REFERENCE SHEET

SHEET NUMBER A00-01A

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TITLE



1/8" = 1'-0"

#### **DEMOLITION GENERAL NOTES**

NO SCOPE OUTSIDE OF THE BUILDING ENVELOPE HAS BEEN IDENTIFIED. WHEN SYSTEMS TO BE DEMOLISHED PENETRATE THE EXTERIOR ENVELOPE, TAKE CARE TO NOT DAMAGE ADJACENT SURFACES.

- THESE DRAWINGS HAVE BEEN DEVELOPED FROM EXISTING DRAWINGS WHICH MAY NOT REFLECT ACTUAL FIELD CONDITIONS. VERIFY THESE DRAWINGS WITH EXISTING FIELD CONDITIONS AND NOTIFY THE ARCHITECT IMMEDIATELY OF INCONSISTENCIES BETWEEN THEM AND ACTUAL CONDITIONS BEFORE PROCEEDING WITH
- REMOVE CONSTRUCTION AS INDICATED. TYPICAL WALL REMOVAL INCLUDES FINISHES AND MECHANICAL PLUMBING AND ELECTRICAL SYSTEMS CONTAINED THEREIN. REMOVE DOORS, CASEWORK, WINDOWS, FRAMES, AND OTHER FIXTURES AS REQUIRED. AFTER REMOVAL OF PIPE CHASES, PATCH HOLES IN FLOORS OR WALLS TO REMAIN TO MEET ORIGINAL FIRE PROTECTION AND STRUCTURAL REQUIREMENTS. PATCH ADJOINING WALLS, FLOORS AND DECK, AND PREPARE SURFACES TO RECEIVE
- ASSUME NO SALVAGE / RELOCATION OF MATERIALS UNLESS NOTED OTHERWISE.
- SEE MECHANICAL, PLUMBING, AND ELECTRICAL DRAWINGS FOR DEMOLITION OF
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- THE BUILDING ENVELOPE SHALL BE MAINTAINED IN A WATER TIGHT CONDITION AT ALL TIMES. TEMPORARY PARTITIONS / PATCHES TO BE UTILIZED AS NEEDED UNTIL FINAL CONSTRUCTION IS COMPLETED.
- SCHEDULE ALL DEMOLITION WITH THE OWNER.
- 10. IN DEMOLITION REFLECTED CEILING PLANS, CONCRETE STRUCTURE TO REMAIN.
- FLOOR SURFACES THAT ARE NOTED TO BE REMOVED SHOULD BE FULLY DEMOLISHED FROM UNDERNEATH ALL MILLWORK AND FURNITURE, UNO.

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Available Light 5700 Six Forks Road, Suite 203, Raleigh, NC 27609

SUSTAINABILITY **Ecoimpact Consulting** 8022 Providence Road Suite 500, Charlotte, NC 28277

#### **DEMOLITION LEGEND**

EXISTING CONSTRUCTION TO REMAIN

____ EXISTING 2-HR RATED CONSTRUCTION TO REMAIN

CONCRETE FLOOR TO REMAIN.

EPOXY FLOOR TO BE REMOVED COMPLETELY TO SUBSTRATE.

LINOLEUM FLOOR TILES TO BE REMOVED TO SUBSTRATE.

CONSTRUCTION TO BE REMOVED

CERAMIC FLOOR TILES TO BE REMOVED TO SUBSTRATE.

TERRAZZO FLOOR TO REMAIN, PREPARE FOR NEW FINISH.

CARPET TO BE REMOVED TO SUBSTRATE.

<<< Indicates Sheet Keynote on Plan</p>

DM1 REMOVE ALL MILLWORK. REMOVE ALL LAB EQUIPMENT, REFER TO SPECIFICATION

DM3 | ELECTRICAL EQUIPMENT AND WALLS / DOORS / CEILINGS / FLOORS TO REMAIN,


SEE ELEC DRAWINGS.


DM4 HANDRAIL, GUARDRAIL, AND STAIR TREADS, EXISTING TO REMAIN. DM5 REMOVE OVERHEAD CRANE AND ALL ASSOCIATED STRUCTURES.

DM6 REMOVE KNEE WALLS AND REPLACE WITH TEMPORARY PARTITION. DM7 REMOVE CHAIN LINK FENCE. SLAB EDGE TO REMAIN.

DM8 REMOVE ALL PLUMBING FIXTURES, SEE PLUMBING DRAWINGS. DM10 SALVAGE BRICKS AND STORE FOR FUTURE REUSE.

DM11 EXISTING TRENCH COVERS TO BE REMOVED, STORED, AND REINSTALLED AFTER MECHANICAL DEMOLITION IS COMPLETE.

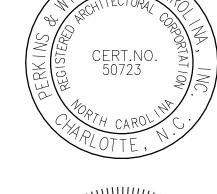

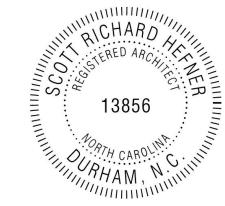

Mann Hall Renovation STATE ID #22-24500-02B NCSU PROJECT # 202220021



**North Carolina State** University Facilities Division Design & Construction Administrative Services Building III

2601 Wolf Village Way, Suite 331

Raleigh, NC 27695

**ISSUE CHART** 


3 ISSUE FOR BID - DEMO REV 1 10/28/2024 1 ISSUE FOR BID - DEMO 4/17/2024 820937.001 Approver

> **DEMOLITION PLAN -**FLOOR 01

> > SHEET NUMBER

TITLE

A04-01

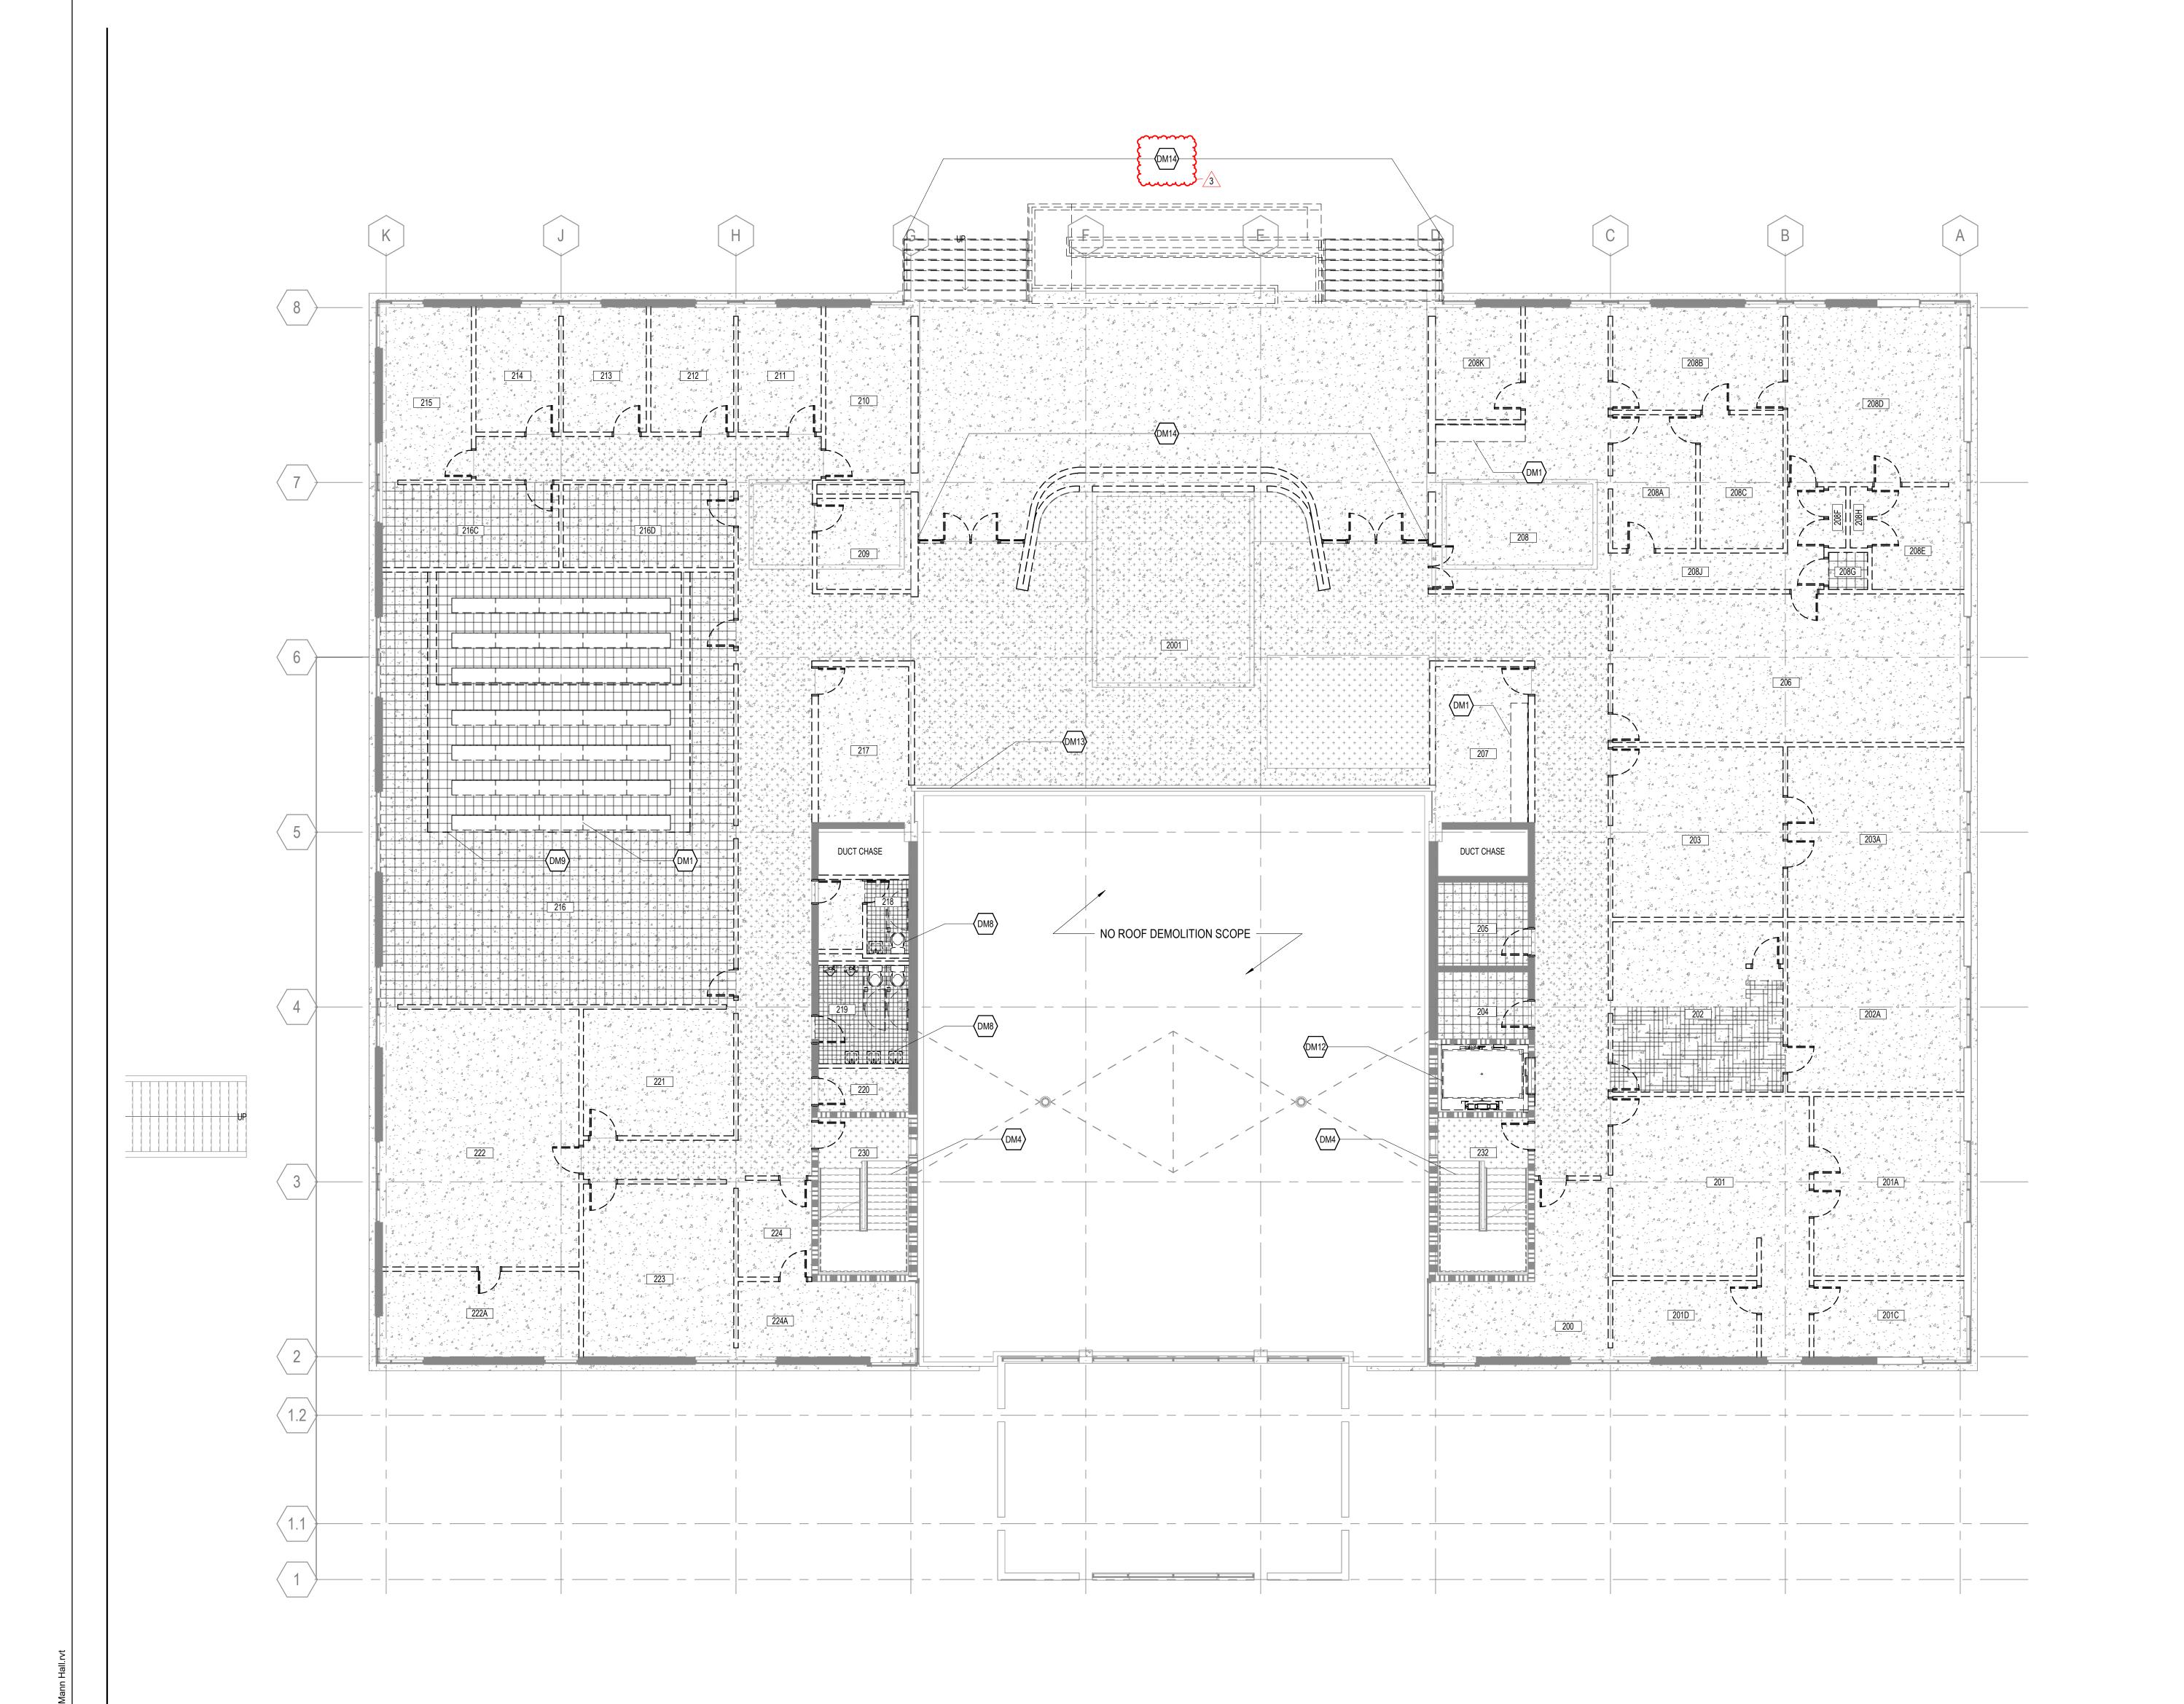

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SUSTAINABILITY

Ecoimpact Consulting 8022 Providence Road Suite 500, Charlotte, NC 28277

#### **DEMOLITION LEGEND**

EXISTING CONSTRUCTION TO REMAIN

EXISTING 2-HR RATED CONSTRUCTION TO REMAIN

CONSTRUCTION TO BE REMOVED

CONCRETE FLOOR TO REMAIN.

EPOXY FLOOR TO BE REMOVED COMPLETELY TO SUBSTRATE.

LINOLEUM FLOOR TILES TO BE REMOVED TO SUBSTRATE.

CERAMIC FLOOR TILES TO BE REMOVED TO SUBSTRATE.

TERRAZZO FLOOR TO REMAIN, PREPARE FOR NEW FINISH.

#### DEMOLITION NOTES BY NUMBER

CARPET TO BE REMOVED TO SUBSTRATE.

<<< Indicates Sheet Keynote on Plan</p>

DM1 REMOVE ALL MILLWORK. REMOVE ALL LAB EQUIPMENT, REFER TO SPECIFICATION

02 41 20.

DM4 HANDRAIL, GUARDRAIL, AND STAIR TREADS, EXISTING TO REMAIN.

DM8 PEMOVE ALL BLUMBING FIXTURES. SEE BLUMBING DRAWINGS.

DM8 REMOVE ALL PLUMBING FIXTURES, SEE PLUMBING DRAWINGS.
DM9 STEPPED PLATFORMS TO BE REMOVED TO ORIGINAL FLOOR LEVEL.


DM12 ALTERNATE 1: REMOVE ELEVATOR CAB, COUNTERWEIGHTS, RAILS, DOOR FRAMES, AND DOORS.

DM13 TEMPORARY PARTITIONS TO REMAIN.

DM13 TEMPORARY PARTITIONS TO REMAIN.

DM14 ALTERNATE 2: REMOVE NORTH ENTRY DOORS, BRICK WALL, SOFFIT, RAMP, AND EXTERIOR STAIRS. PROVIDE TEMPORARY PARTITION AS NEEDED PER GENERAL NOTES



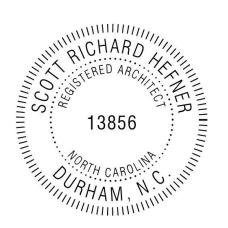

Mann Hall Renovation

STATE ID #22-24500-02B

NCSU PROJECT # 202220021



North Carolina State
University

Facilities Division Design & Construction
Administrative Services Building III
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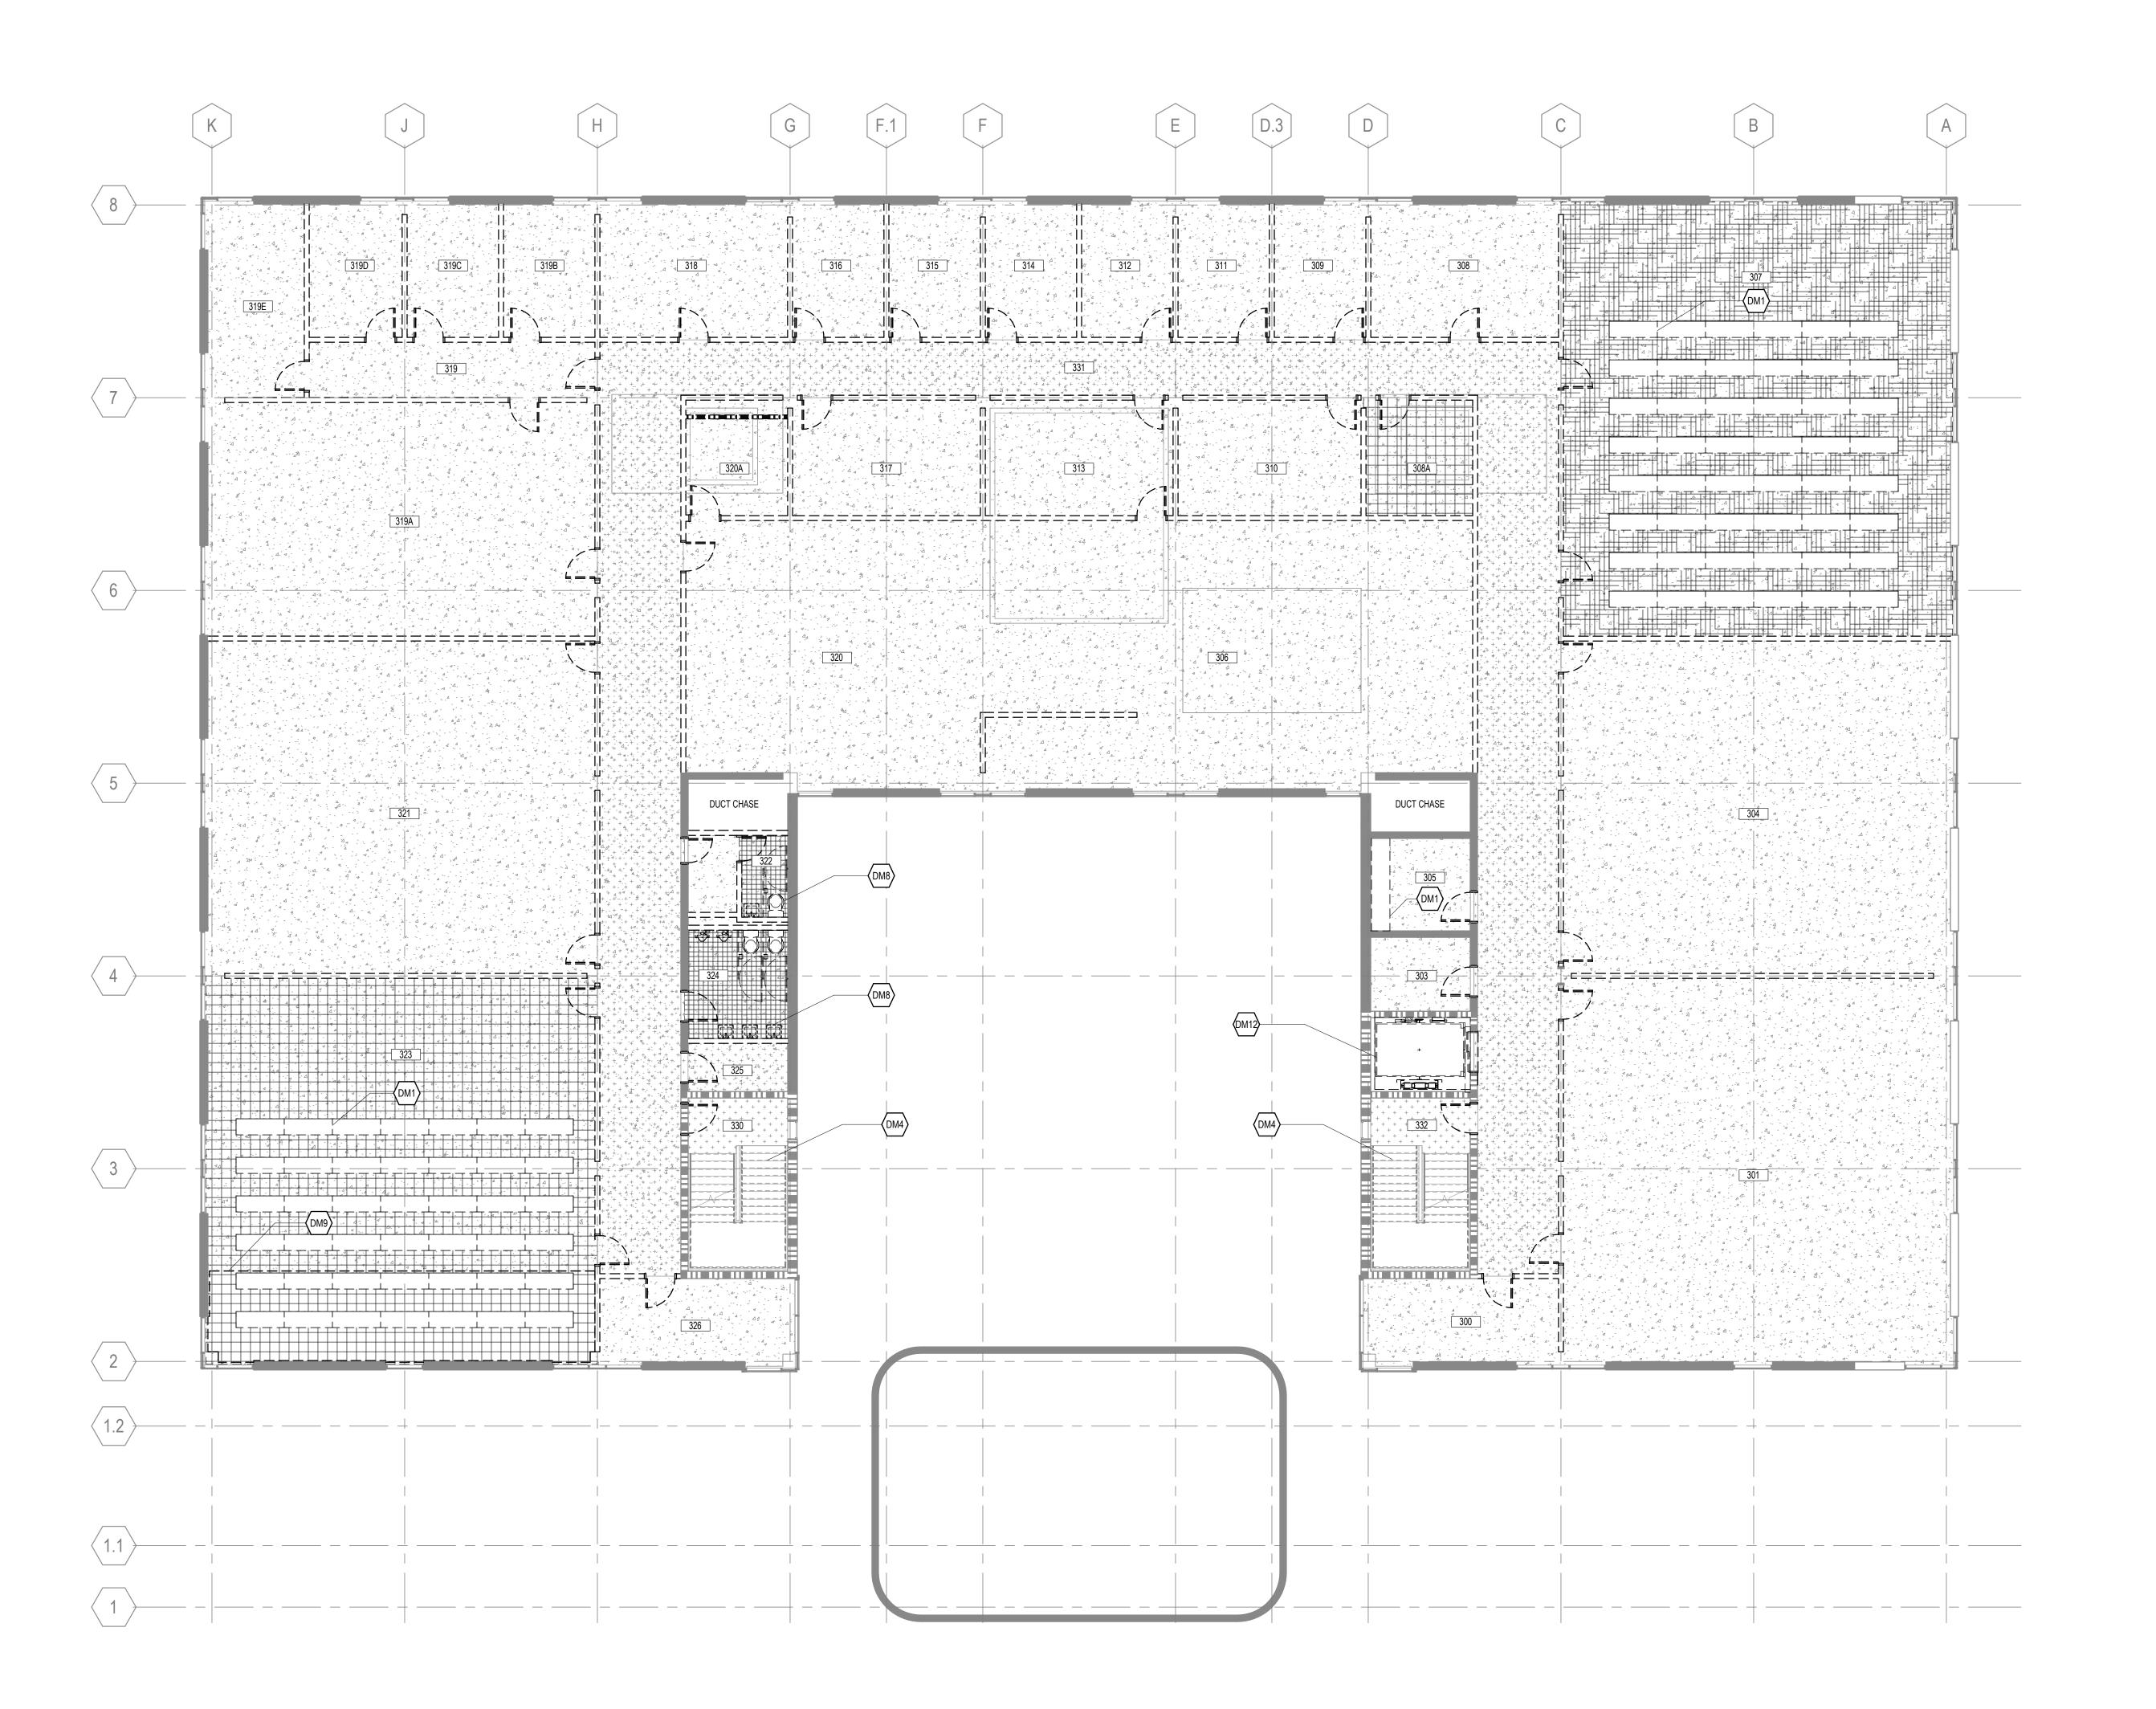


ISSUE CHART

		TITLE
Appro	ved	Approver
Check	ed	Checker
Drawn	1	Author
Job N	umber 82	20937.001
MARK	ISSUE	DATE
1	ISSUE FOR BID - DEMO	4/17/2024
3	ISSUE FOR BID - DEMO REV 1	10/28/2024

DEMOLITION PLAN -FLOOR 02

SHEET NUMBER



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4. ASSUME NO SALVAGE / RELOCATION OF MATERIALS UNLESS NOTED OTHERWISE.

5. SEE MECHANICAL, PLUMBING, AND ELECTRICAL DRAWINGS FOR DEMOLITION OF

6. DEMOLITION WORK SHALL BE EXECUTED IN CONFORMANCE WITH ALL CODES AND AS SET FORTH BY ALL GOVERNING AUTHORITIES.

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 THE BUILDING ENVELOPE SHALL BE MAINTAINED IN A WATER TIGHT CONDITION AT ALL

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9. SCHEDULE ALL DEMOLITION WITH THE OWNER.

10. IN DEMOLITION REFLECTED CEILING PLANS, CONCRETE STRUCTURE TO REMAIN.
 11. FLOOR SURFACES THAT ARE NOTED TO BE REMOVED SHOULD BE FULLY DEMOLISHED

FROM UNDERNEATH ALL MILLWORK AND FURNITURE, UNO.

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Available Light

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t 919.433.5300

Salas O'Brien

License (NC): F-1434

Ecoimpact Consulting 8022 Providence Road Suite 500, Charlotte, NC 28277

#### DEMOLITION LEGEND

EXISTING CONSTRUCTION TO REMAIN

EXISTING 2-HR RATED CONSTRUCTION TO REMAIN

CONSTRUCTION TO BE REMOVED

CONCRETE FLOOR TO REMAIN.

EPOXY FLOOR TO BE REMOVED COMPLETELY TO SUBSTRATE.

LINOLEUM FLOOR TILES TO BE REMOVED TO SUBSTRATE.

CERAMIC FLOOR TILES TO BE REMOVED TO SUBSTRATE.

TERRAZZO FLOOR TO REMAIN, PREPARE FOR NEW FINISH.

#### **DEMOLITION NOTES BY NUMBER**

CARPET TO BE REMOVED TO SUBSTRATE.

Indicates Sheet Keynote on Plan

FRAMES, AND DOORS.

DM1 REMOVE ALL MILLWORK. REMOVE ALL LAB EQUIPMENT, REFER TO SPECIFICATION

DM4 HANDRAIL, GUARDRAIL, AND STAIR TREADS, EXISTING TO REMAIN.

DM8 REMOVE ALL PLUMBING FIXTURES, SEE PLUMBING DRAWINGS.

DM9 STEPPED PLATFORMS TO BE REMOVED TO ORIGINAL FLOOR LEVEL.

DM12 ALTERNATE 1: REMOVE ELEVATOR CAB, COUNTERWEIGHTS, RAILS, DOOR

TARLOTTE,

CHARD

Mann Hall Renovation

STATE ID #22-24500-02B

NCSU PROJECT # 202220021



North Carolina State
University

Facilities Division Design & Construction
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ISSUE CHART

 3
 ISSUE FOR BID - DEMO REV 1
 10/28/2024

 1
 ISSUE FOR BID - DEMO
 4/17/2024

 MARK
 ISSUE
 DATE

 Job Number
 820937.001

 Drawn
 Author


 Checked
 Checker

 Approved
 Approver

DEMOLITION PLAN -FLOOR 03

SHEET NUMBER

TITLE

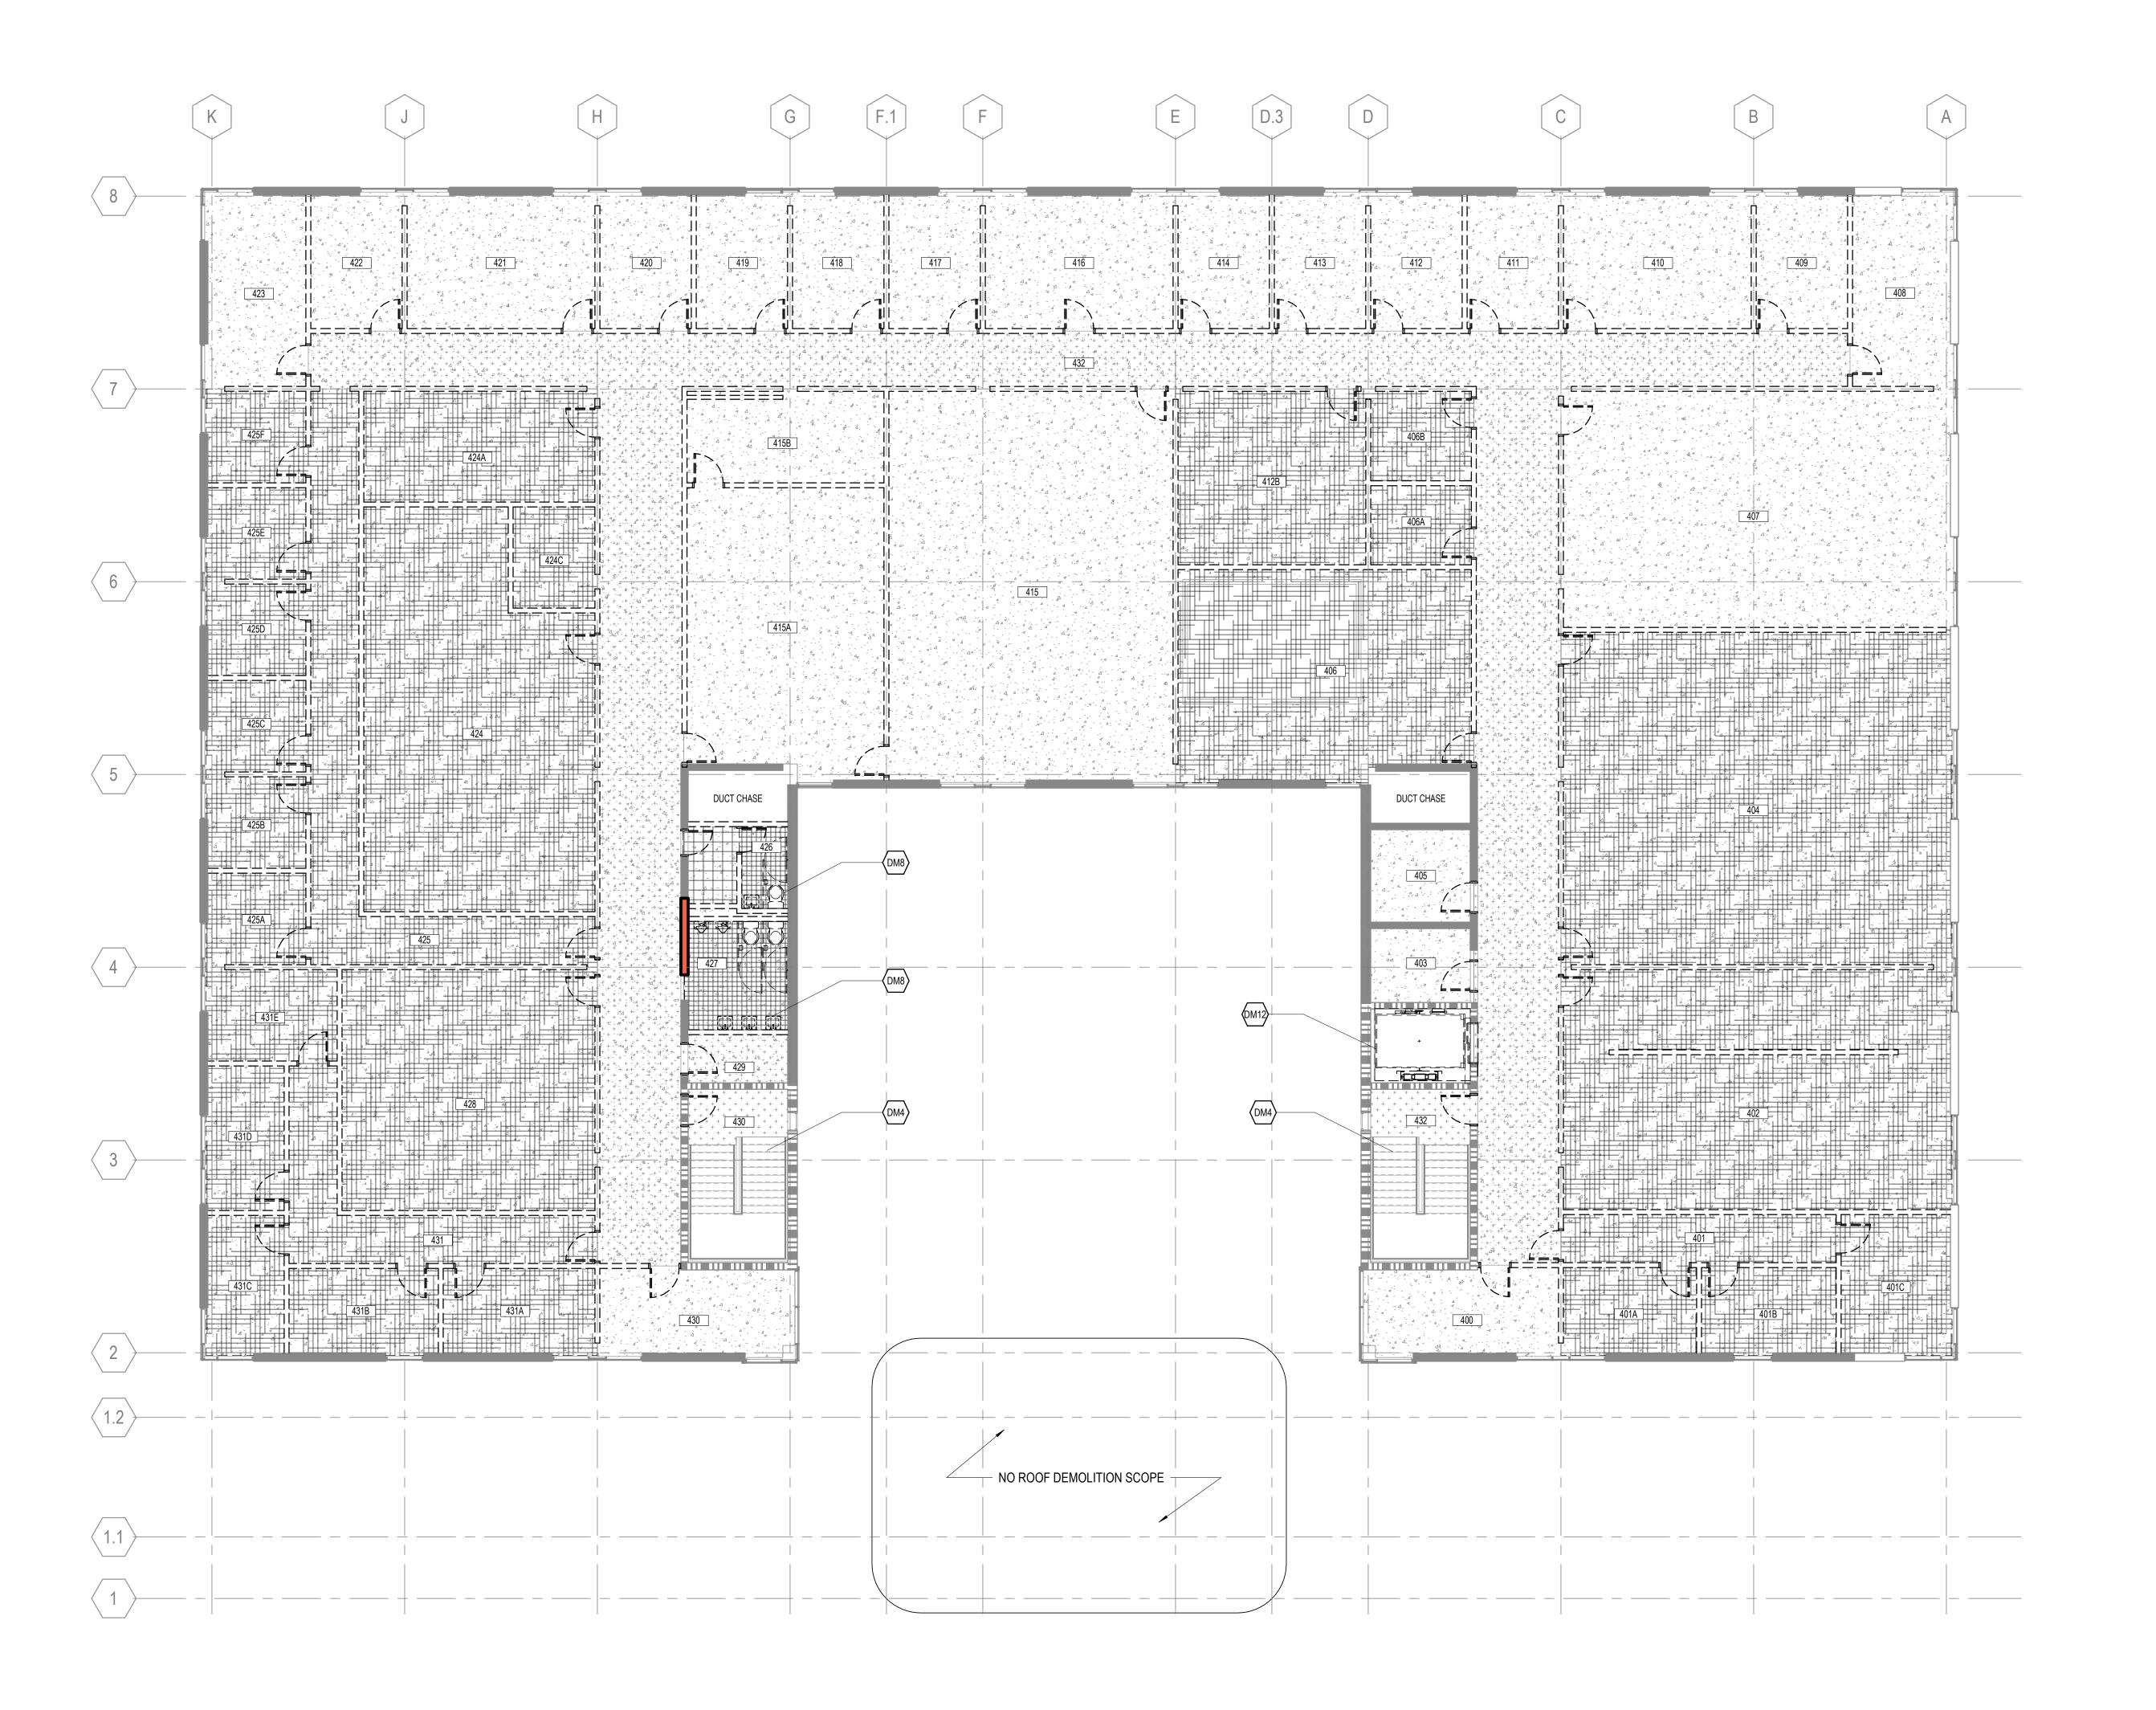

NO SCOPE OUTSIDE OF THE BUILDING ENVELOPE HAS BEEN IDENTIFIED. WHEN SYSTEMS TO BE DEMOLISHED PENETRATE THE EXTERIOR ENVELOPE, TAKE CARE TO NOT DAMAGE ADJACENT SURFACES.

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- 9. SCHEDULE ALL DEMOLITION WITH THE OWNER.
- 10. IN DEMOLITION REFLECTED CEILING PLANS, CONCRETE STRUCTURE TO REMAIN. FLOOR SURFACES THAT ARE NOTED TO BE REMOVED SHOULD BE FULLY DEMOLISHED FROM UNDERNEATH ALL MILLWORK AND FURNITURE, UNO.

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SUSTAINABILITY **Ecoimpact Consulting** 8022 Providence Road Suite 500, Charlotte, NC 28277

#### **DEMOLITION LEGEND**

EXISTING CONSTRUCTION TO REMAIN EXISTING 2-HR RATED CONSTRUCTION TO REMAIN CONSTRUCTION TO BE REMOVED CONCRETE FLOOR TO REMAIN. EPOXY FLOOR TO BE REMOVED COMPLETELY TO SUBSTRATE.

LINOLEUM FLOOR TILES TO BE REMOVED TO SUBSTRATE.

CERAMIC FLOOR TILES TO BE REMOVED TO SUBSTRATE. TERRAZZO FLOOR TO REMAIN, PREPARE FOR NEW FINISH.


CARPET TO BE REMOVED TO SUBSTRATE.

#### **DEMOLITION NOTES BY NUMBER**

<<< Indicates Sheet Keynote on Plan</p>

DM4 HANDRAIL, GUARDRAIL, AND STAIR TREADS, EXISTING TO REMAIN. DM8 REMOVE ALL PLUMBING FIXTURES, SEE PLUMBING DRAWINGS.

DM12 ALTERNATE 1: REMOVE ELEVATOR CAB, COUNTERWEIGHTS, RAILS, DOOR

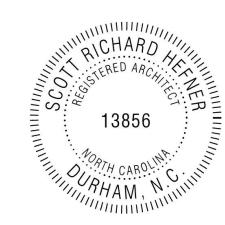

Mann Hall Renovation STATE ID #22-24500-02B NCSU PROJECT # 202220021



**North Carolina State** University Facilities Division Design & Construction Administrative Services Building III 2601 Wolf Village Way, Suite 331 Raleigh, NC 27695



**ISSUE CHART** 

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Check	red.	Checker
Drawr	1	Author
Job N	umber 82	20937.001
MARK	ISSUE	DATE
1	ISSUE FOR BID - DEMO	4/17/2024
3	ISSUE FOR BID - DEMO REV 1	10/28/2024


**DEMOLITION PLAN -**FLOOR 04

TITLE

SHEET NUMBER

A04-04

1/8" = 1'-0"

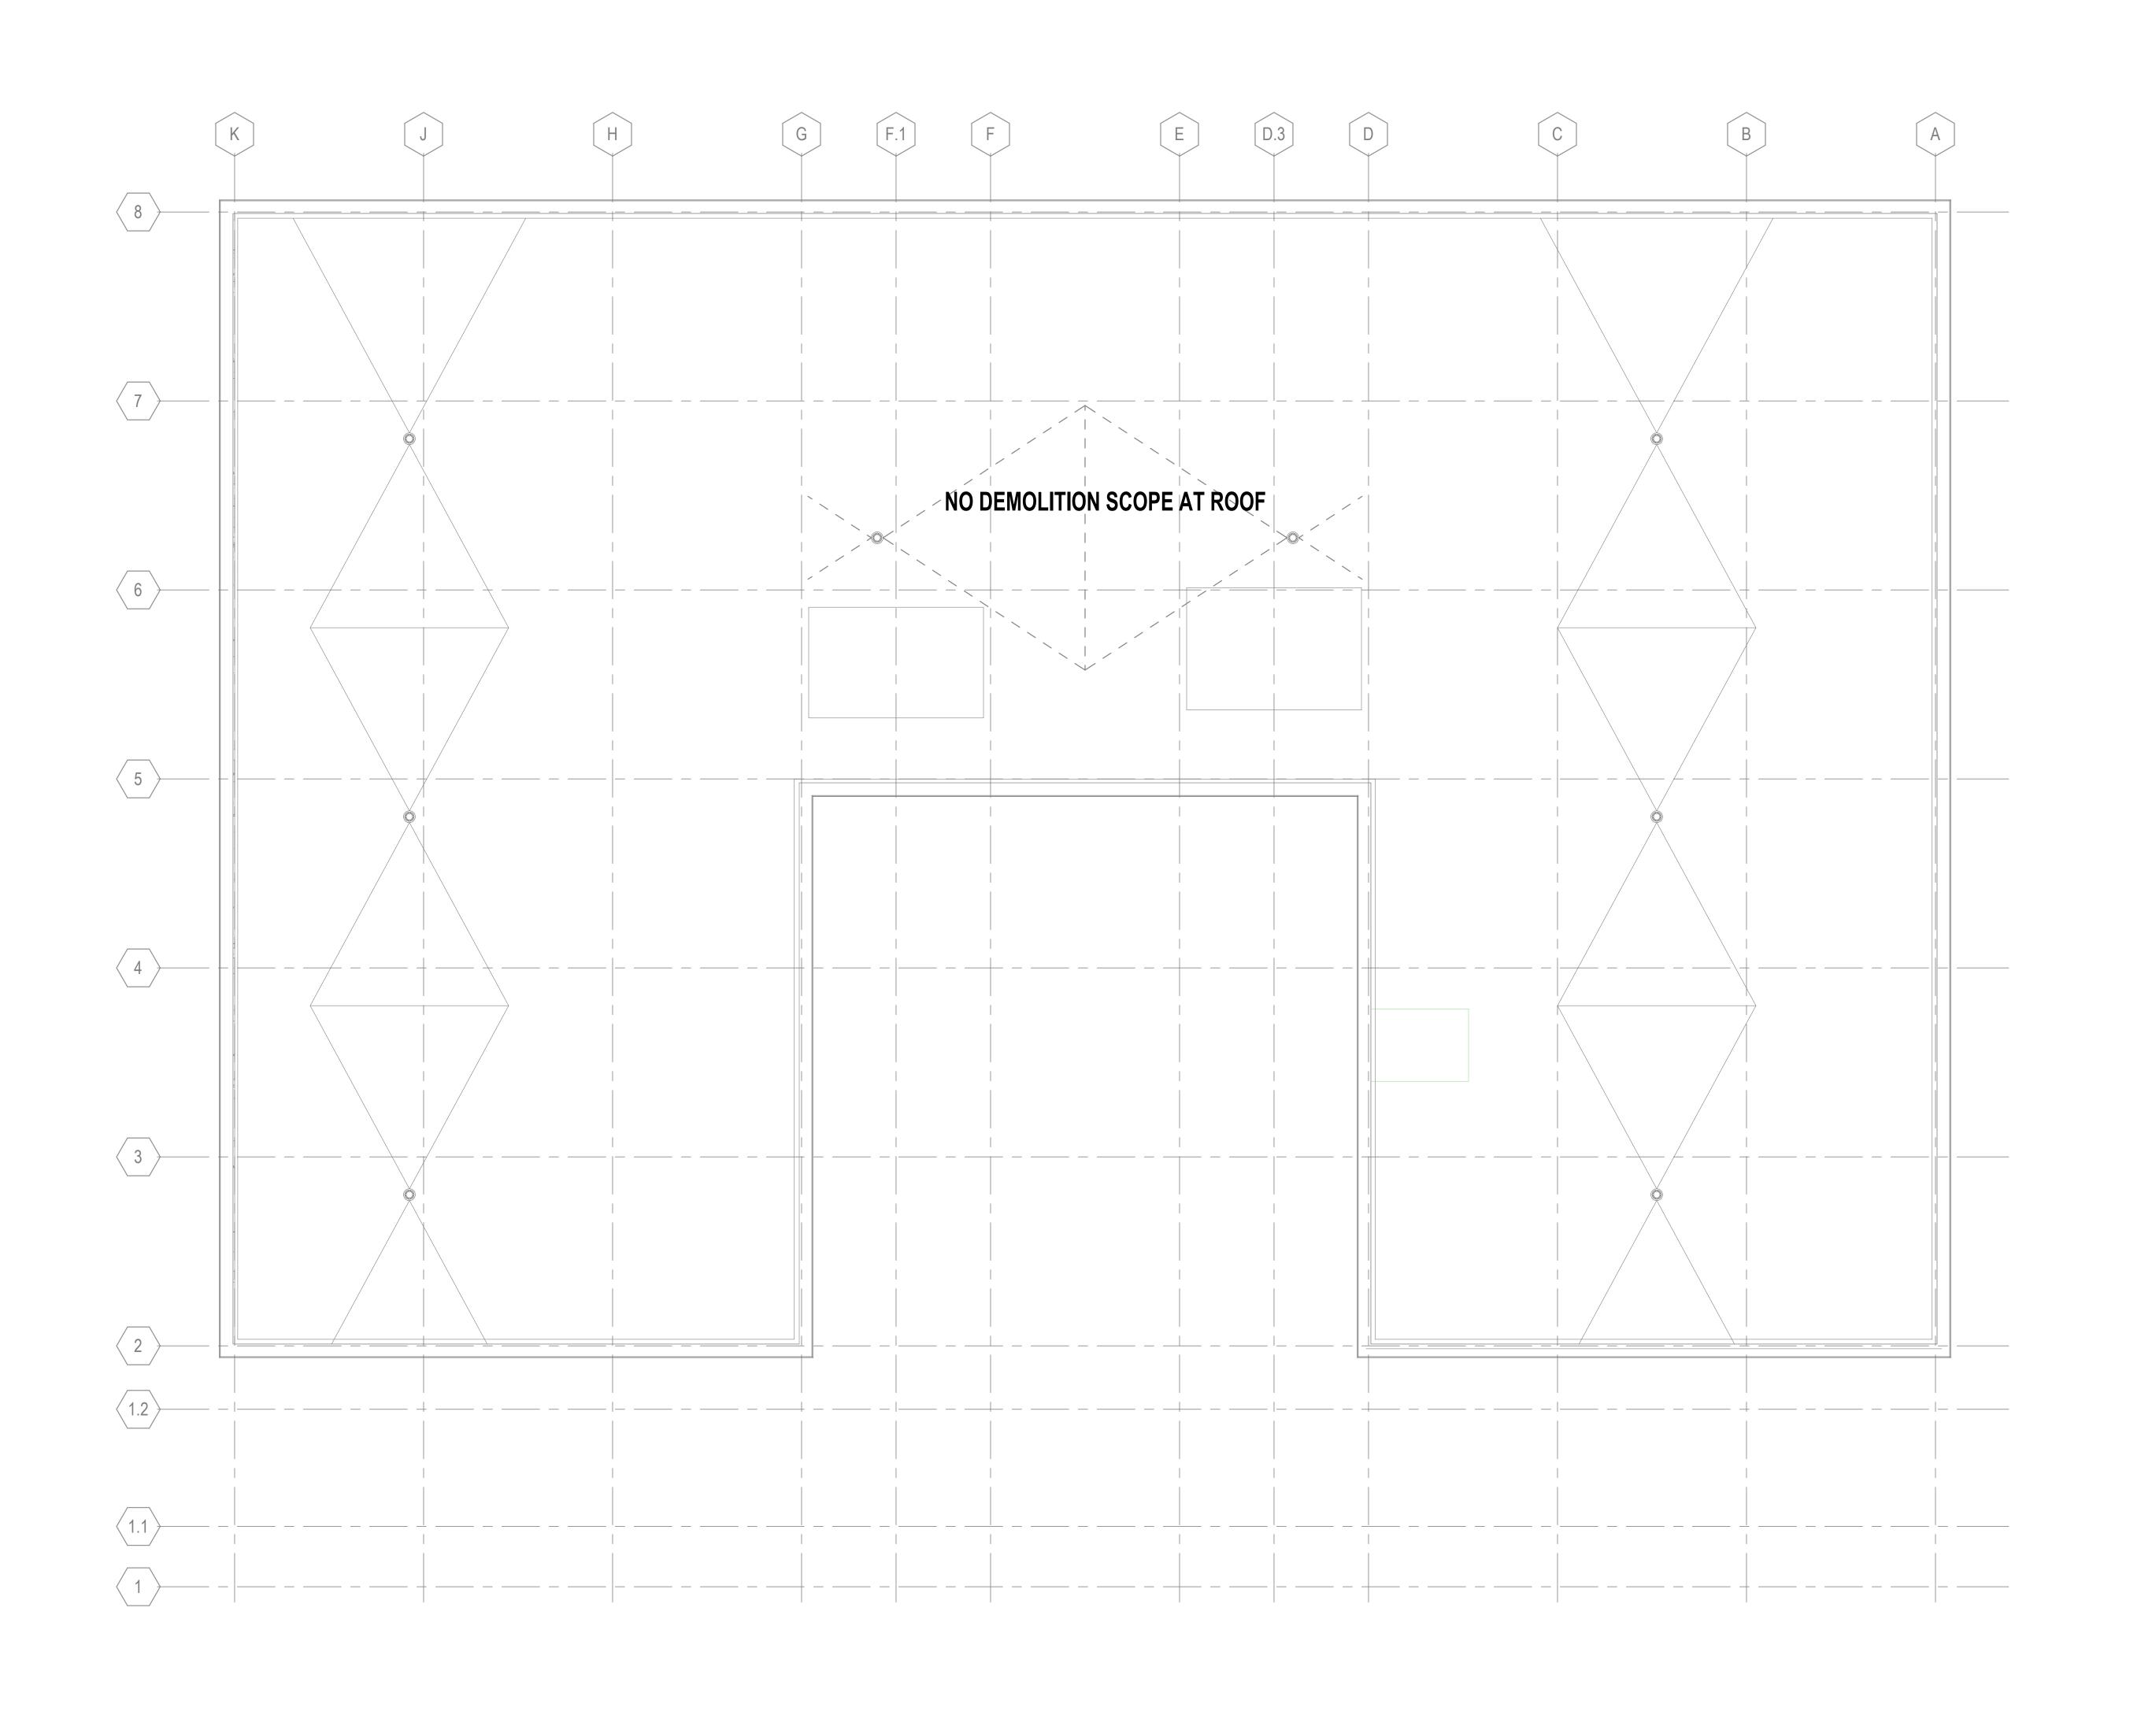

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CONSTRUCTION IS COMPLETED.

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EXISTING 2-HR RATED CONSTRUCTION TO REMAIN

CONSTRUCTION TO BE REMOVED

CONCRETE FLOOR TO REMAIN.

EPOXY FLOOR TO BE REMOVED COMPLETELY TO SUBSTRATE.

LINOLEUM FLOOR TILES TO BE REMOVED TO SUBSTRATE.


CERAMIC FLOOR TILES TO BE REMOVED TO SUBSTRATE.


TERRAZZO FLOOR TO REMAIN, PREPARE FOR NEW FINISH.

### DEMOLITION NOTES BY NUMBER

CARPET TO BE REMOVED TO SUBSTRATE.

<<< Indicates Sheet Keynote on Plan</p>

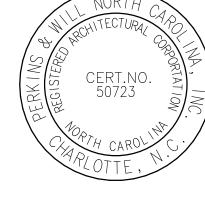

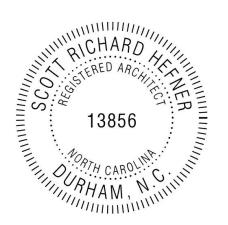

Mann Hall Renovation

STATE ID #22-24500-02B

NCSU PROJECT # 202220021



North Carolina State
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ISSUE CHART

Appro		Approver
Check	red.	Checker
Drawr	1	Author
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MARK	ISSUE	DATE
1	ISSUE FOR BID - DEMO	4/17/2024
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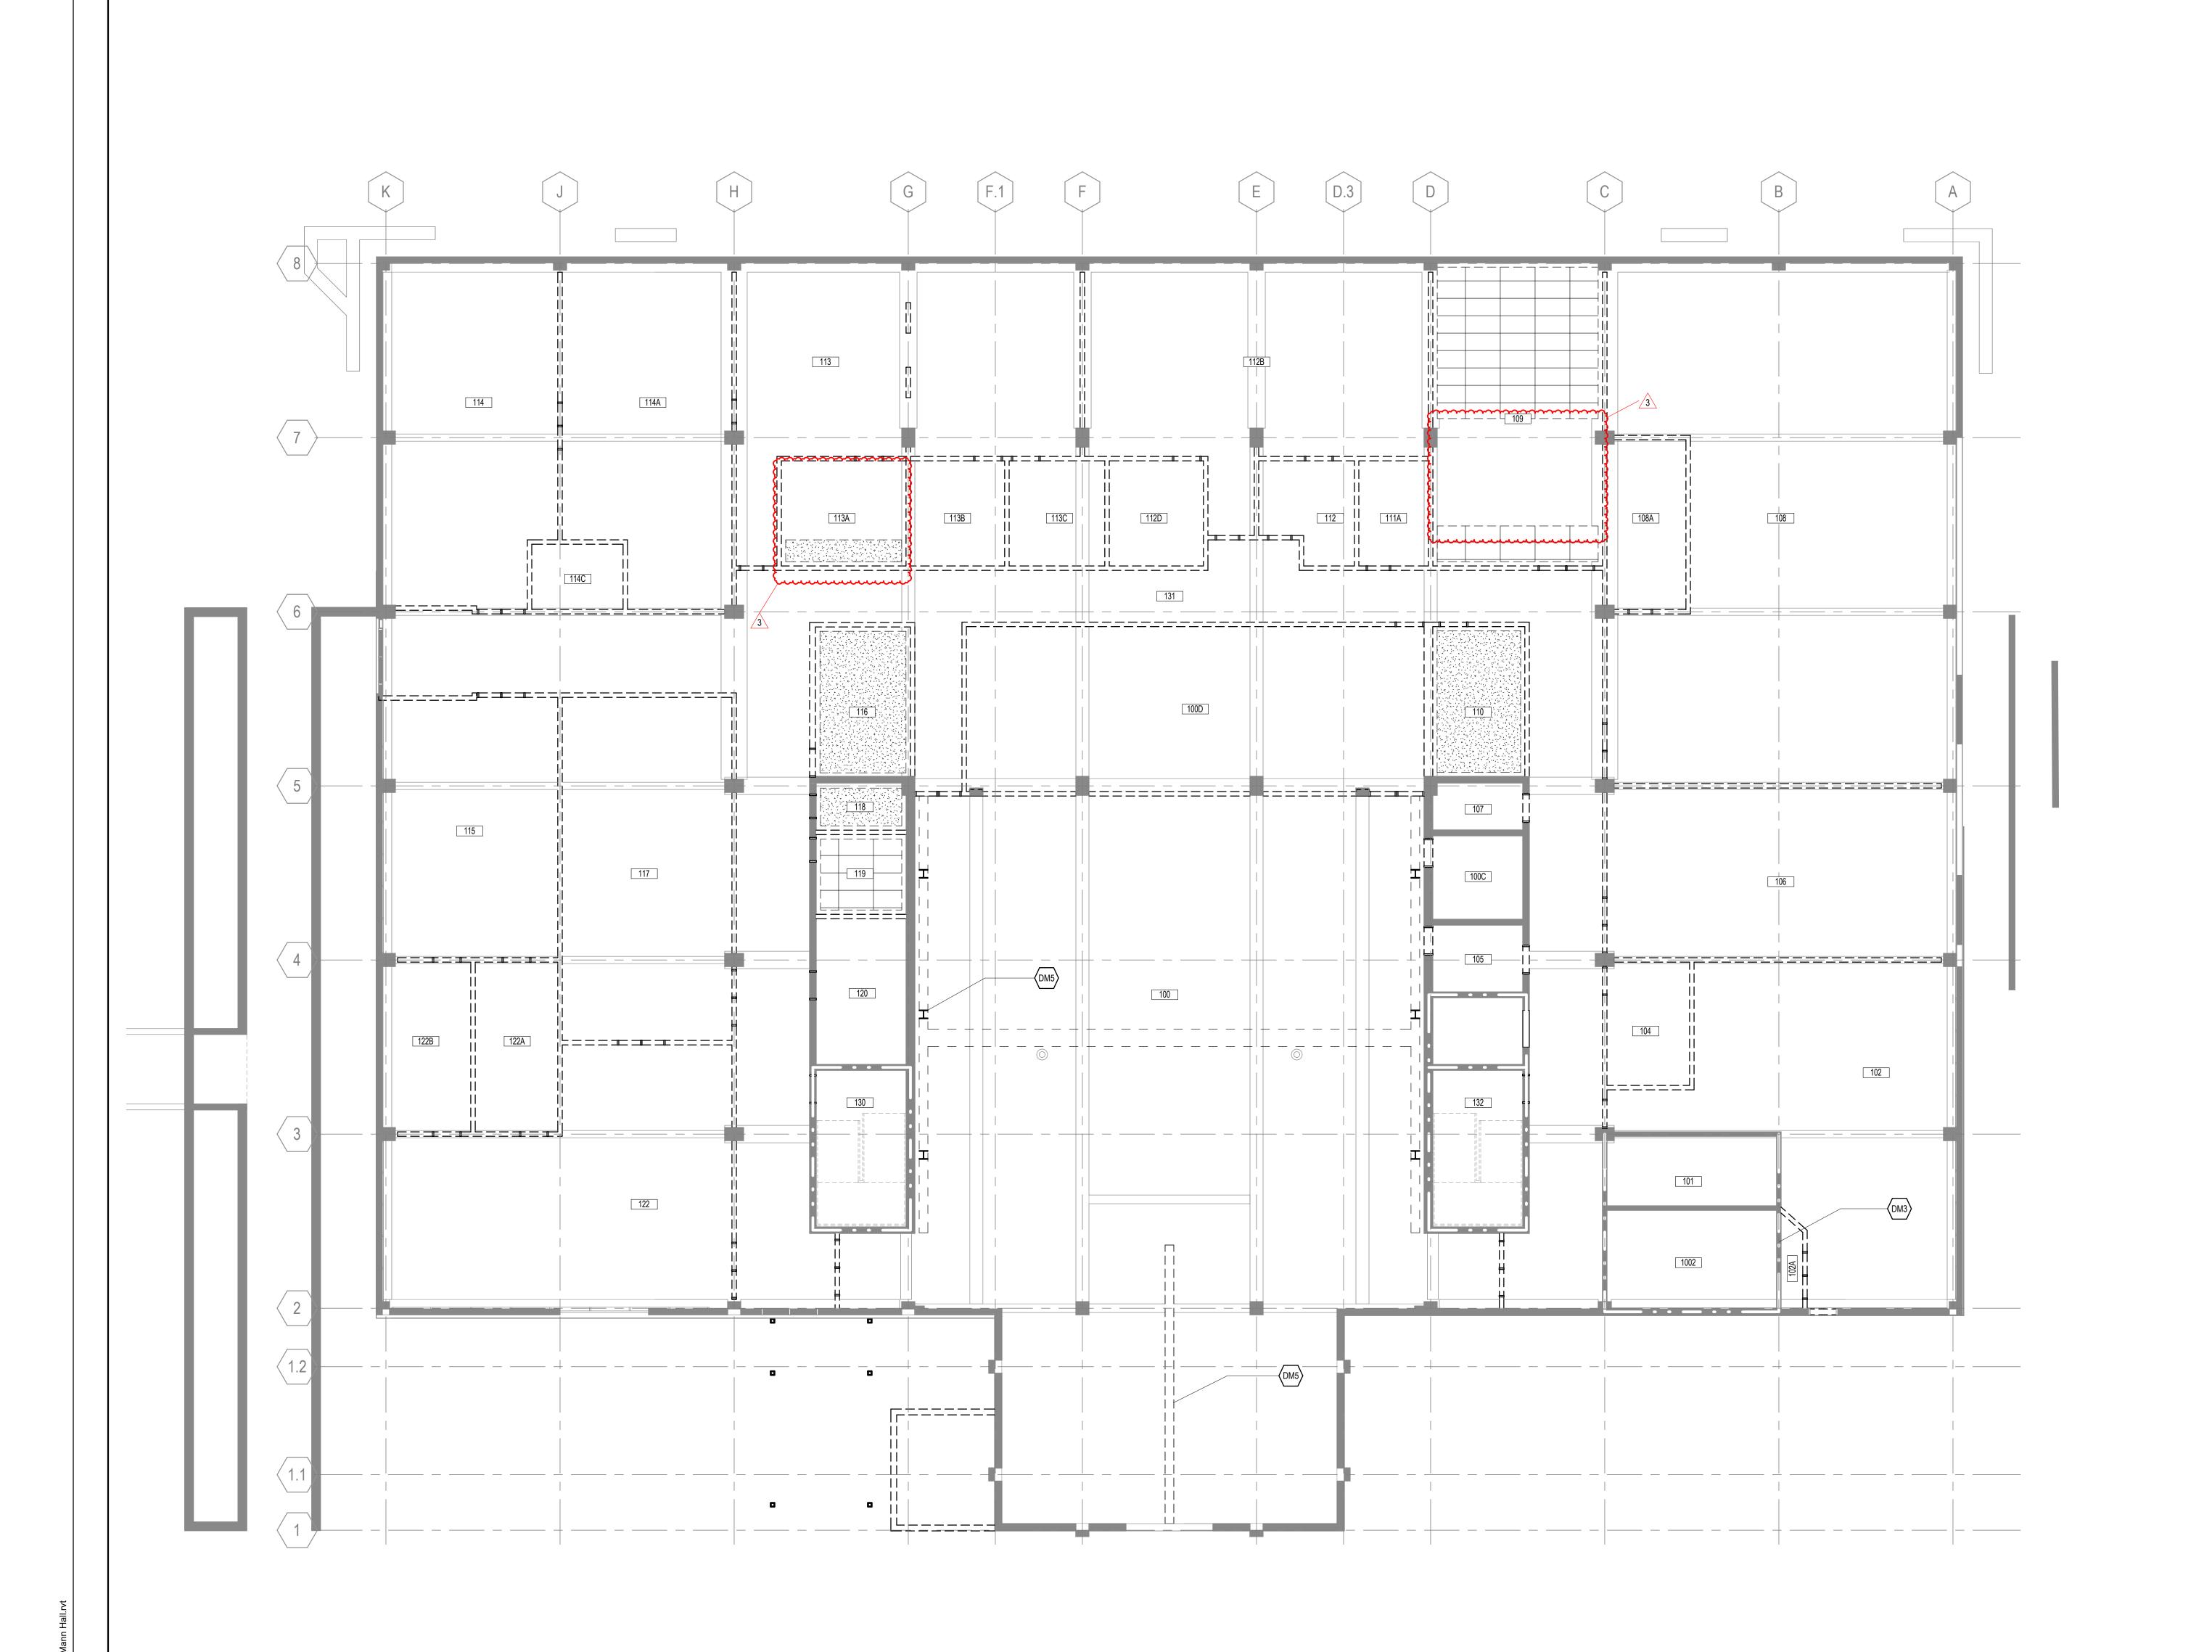
DEMOLITION PLAN -

TITLE

SHEET NUMBER

A04-05

1/8" = 1'-0"



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STRUCTURAL ENGINEER.

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**DEMOLITION LEGEND** 

EXISTING CONSTRUCTION TO REMAIN

CONSTRUCTION TO BE REMOVED

GYPSUM CEILING TO BE REMOVED.

STUCCO CEILING TO BE REMOVED.

12" x 12" APC TO BE REMOVED.

24" x 24" APC TO BE REMOVED.

24" x 48" APC TO BE REMOVED.

<<< Indicates Sheet Keynote on Plan</p>

**DEMOLITION NOTES BY NUMBER** 

DM3 ELECTRICAL EQUIPMENT AND WALLS / DOORS / CEILINGS / FLOORS TO REMAIN, SEE ELEC DRAWINGS.

DM5 REMOVE OVERHEAD CRANE AND ALL ASSOCIATED STRUCTURES.

======

EXISTING 2-HR RATED CONSTRUCTION TO REMAIN

## Perkins&Will

411 W. Chapel Hill Street Suite 200 Durham, NC 27701 t 919.433.5300

www.perkinswill.com

CONSULTANTS

STRUCTURAL

Lynch Mykins Structural Engineers
301 N. West Street Suite 105, Raleigh, NC 27603

Salas O'Brien 702 Oberlin Road, Raleigh, NC 27605 License (NC): F-1434

NV5 Engineers and Consultants
3300 Regency Parkway Suite 100, Cary, NC 27518

CONTRACTOR
Holder Construction Group

6210 Ardrey Kell Road Suite 400, Charlotte, NC 28277


NV5 Engineers and Consultants
4905 Professional Court, Raleigh, NC 27609

центіме Available Light

Available Light 5700 Six Forks Road, Suite 203, Raleigh, NC 27609

SUSTAINABILITY
Ecoimpact Consulting
8022 Providence Road Suite 500, Charlotte, NC 28277



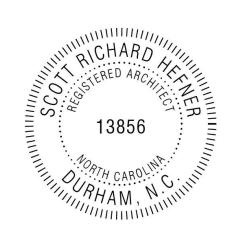

Mann Hall Renovation

STATE ID #22-24500-02B

NCSU PROJECT # 202220021

## NC STATE INIVERSITY

North Carolina State
University
Facilities Division Design & Construction
Administrative Services Building III
2601 Wolf Village Way, Suite 331

Raleigh, NC 27695




ISSUE CHART

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Job Number 82		20937.001
MARK	ISSUE	DATE
1	ISSUE FOR BID - DEMO	4/17/2024
3	ISSUE FOR BID - DEMO REV 1	10/28/2024

DEMOLITION REFLECTED CEILING PLAN - FLOOR 01

Approver

SHEET NUMBER

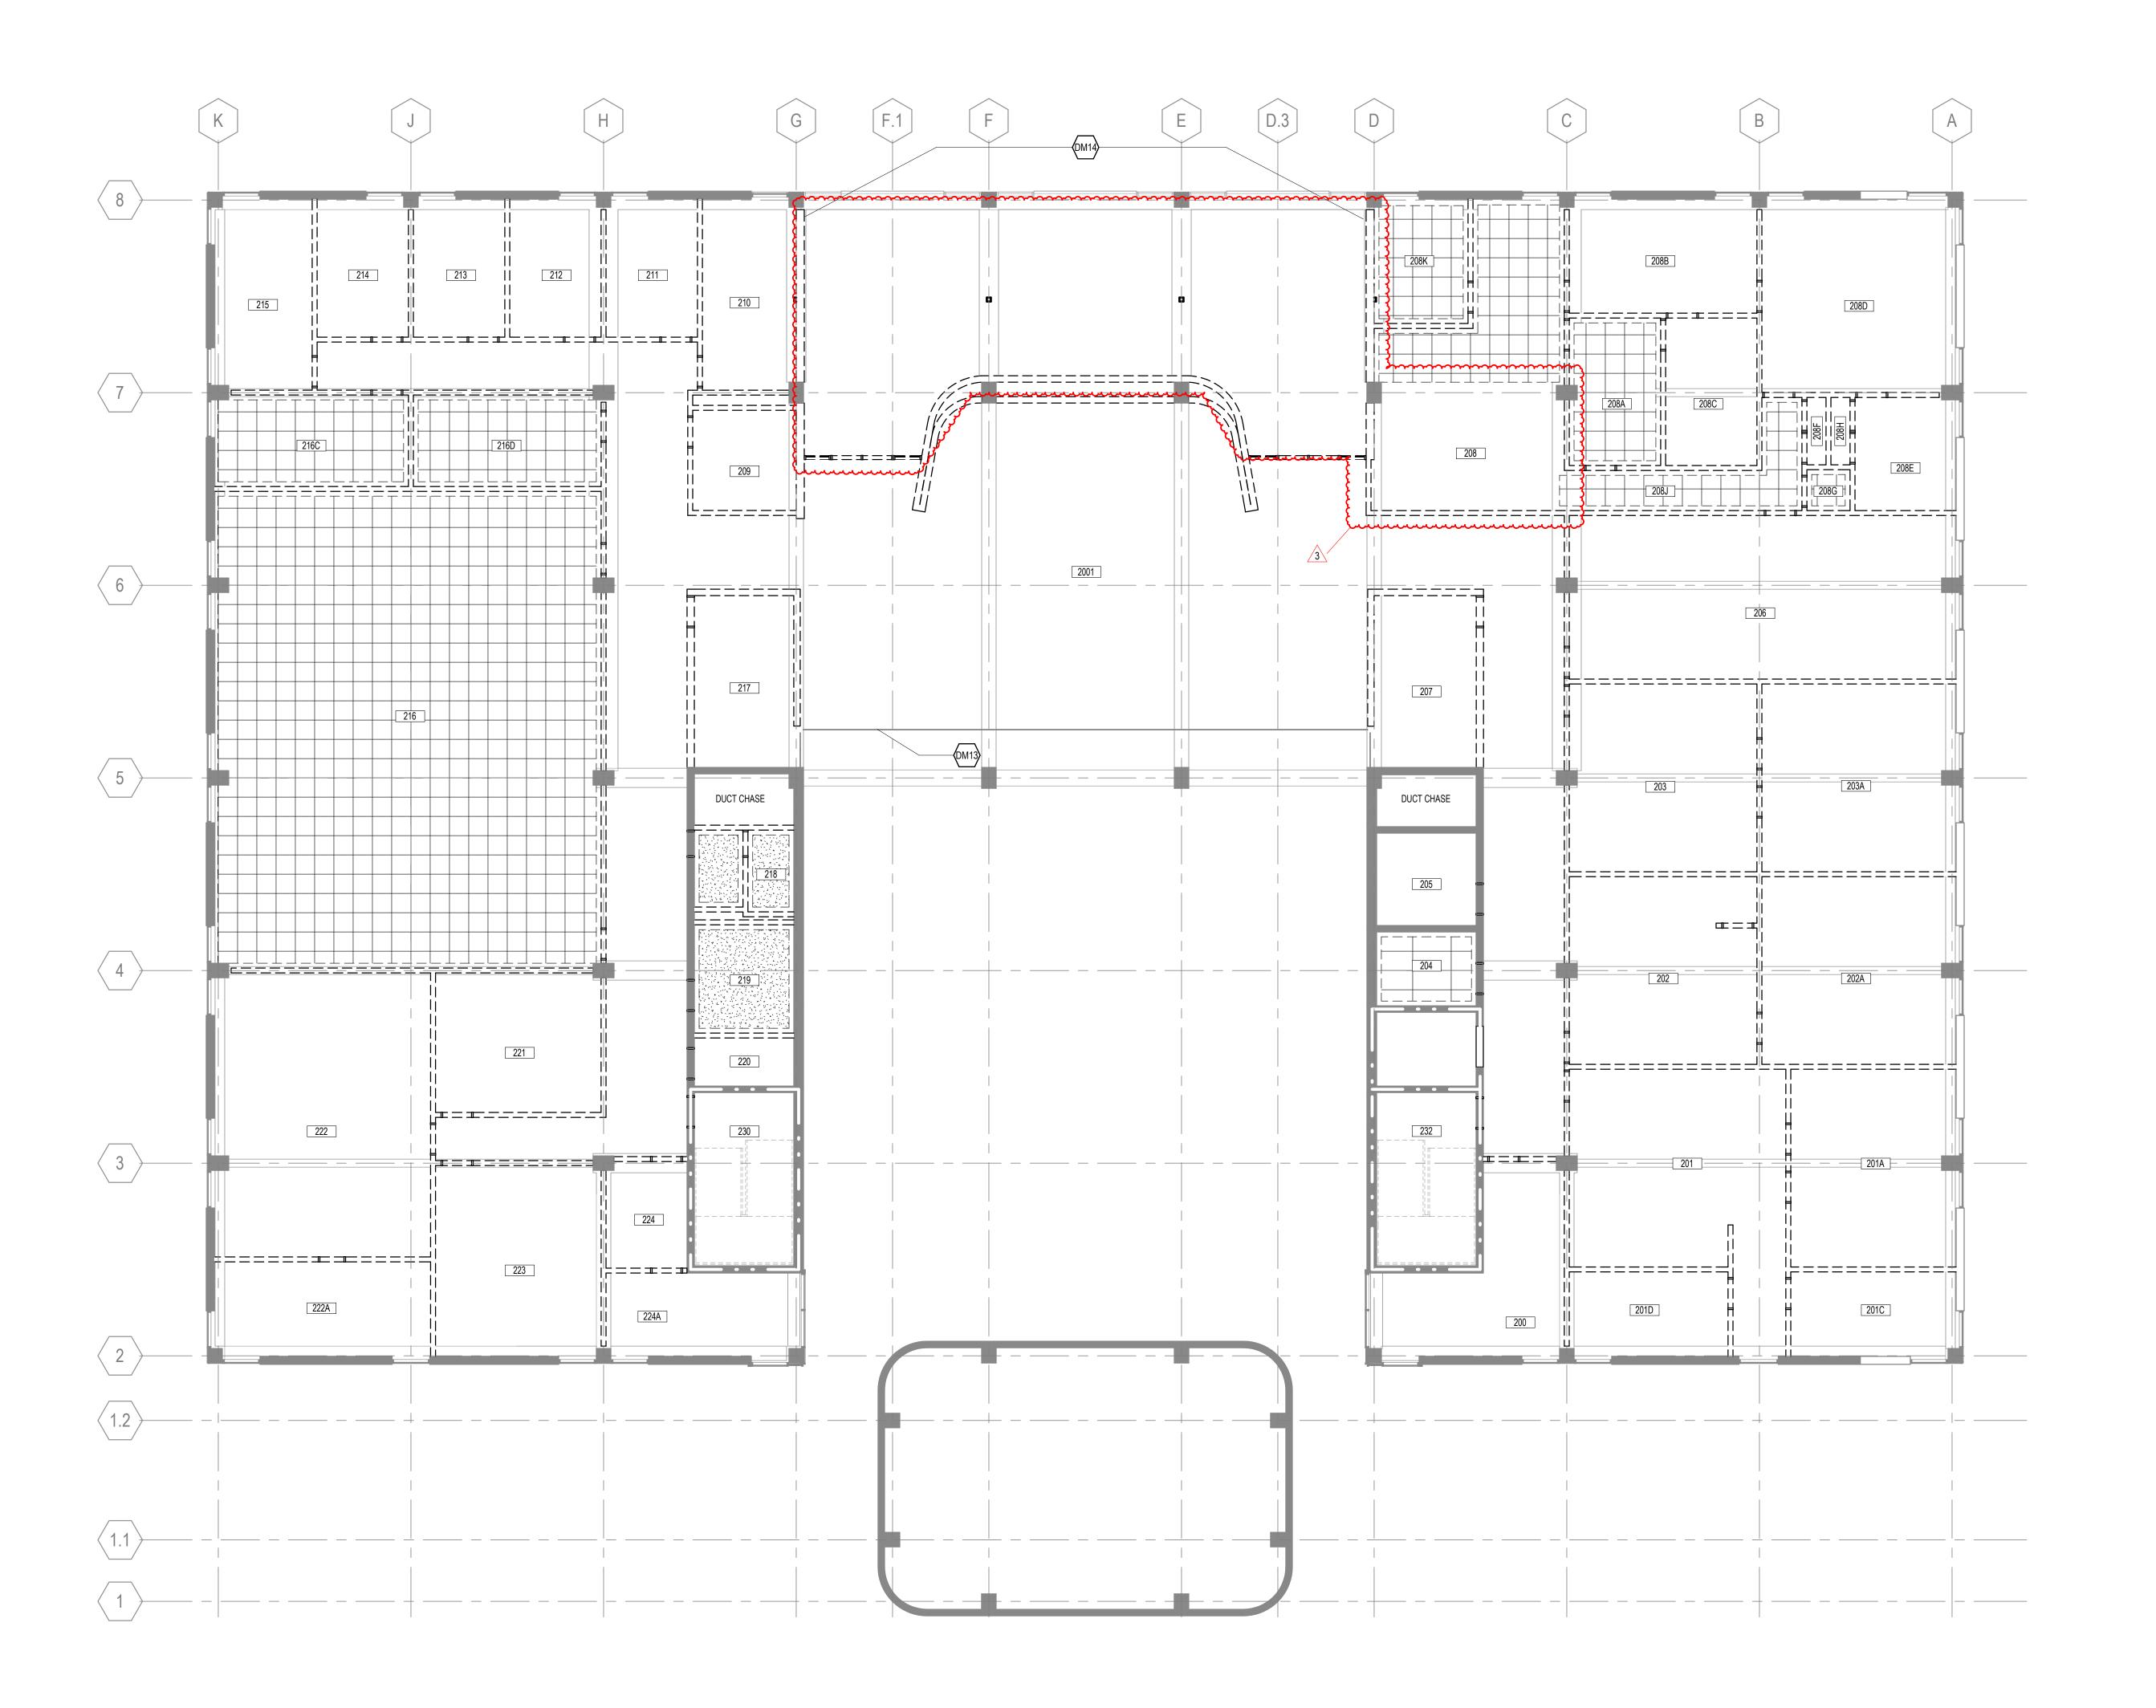

 NO SCOPE OUTSIDE OF THE BUILDING ENVELOPE HAS BEEN IDENTIFIED. WHEN SYSTEMS TO BE DEMOLISHED PENETRATE THE EXTERIOR ENVELOPE, TAKE CARE TO NOT DAMAGE ADJACENT SURFACES.

- 2. THESE DRAWINGS HAVE BEEN DEVELOPED FROM EXISTING DRAWINGS WHICH MAY NOT REFLECT ACTUAL FIELD CONDITIONS. VERIFY THESE DRAWINGS WITH EXISTING FIELD CONDITIONS AND NOTIFY THE ARCHITECT IMMEDIATELY OF INCONSISTENCIES BETWEEN THEM AND ACTUAL CONDITIONS BEFORE PROCEEDING WITH CONSTRUCTION
- REMOVE CONSTRUCTION AS INDICATED. TYPICAL WALL REMOVAL INCLUDES FINISHES AND MECHANICAL PLUMBING AND ELECTRICAL SYSTEMS CONTAINED THEREIN. REMOVE DOORS, CASEWORK, WINDOWS, FRAMES, AND OTHER FIXTURES AS REQUIRED. AFTER REMOVAL OF PIPE CHASES, PATCH HOLES IN FLOORS OR WALLS TO REMAIN TO MEET ORIGINAL FIRE PROTECTION AND STRUCTURAL REQUIREMENTS. PATCH ADJOINING WALLS, FLOORS AND DECK, AND PREPARE SURFACES TO RECEIVE
- 4. ASSUME NO SALVAGE / RELOCATION OF MATERIALS UNLESS NOTED OTHERWISE.
- 5. SEE MECHANICAL, PLUMBING, AND ELECTRICAL DRAWINGS FOR DEMOLITION OF
- DEMOLITION WORK SHALL BE EXECUTED IN CONFORMANCE WITH ALL CODES AND AS SET FORTH BY ALL GOVERNING AUTHORITIES.
   DO NOT PERFORM ANY STRUCTURAL WORK WITHOUT PRIOR APPROVAL FROM THE
- STRUCTURAL ENGINEER.

  THE BUILDING ENVELOPE SHALL BE MAINTAINED IN A WATER TIGHT CONDITION AT ALL
- 8. THE BUILDING ENVELOPE SHALL BE MAINTAINED IN A WATER TIGHT CONDITION AT ALL TIMES. TEMPORARY PARTITIONS / PATCHES TO BE UTILIZED AS NEEDED UNTIL FINAL CONSTRUCTION IS COMPLETED.
- 9. SCHEDULE ALL DEMOLITION WITH THE OWNER.
- 10. IN DEMOLITION REFLECTED CEILING PLANS, CONCRETE STRUCTURE TO REMAIN.

**DEMOLITION LEGEND** 

EXISTING CONSTRUCTION TO REMAIN

CONSTRUCTION TO BE REMOVED

GYPSUM CEILING TO BE REMOVED.

STUCCO CEILING TO BE REMOVED.

12" x 12" APC TO BE REMOVED.

24" x 24" APC TO BE REMOVED.

24" x 48" APC TO BE REMOVED.

<<< Indicates Sheet Keynote on Plan</p>

DM13 TEMPORARY PARTITIONS TO REMAIN.

**DEMOLITION NOTES BY NUMBER** 

DM14 ALTERNATE 2: REMOVE NORTH ENTRY DOORS, BRICK WALL, SOFFIT, RAMP, AND

EXTERIOR STAIRS. PROVIDE TEMPORARY PARTITION AS NEEDED PER GENERAL

======

EXISTING 2-HR RATED CONSTRUCTION TO REMAIN

FLOOR SURFACES THAT ARE NOTED TO BE REMOVED SHOULD BE FULLY DEMOLISHED FROM UNDERNEATH ALL MILLWORK AND FURNITURE, UNO.

## Perkins&Will

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CONSULTANTS

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AUDIO/VISUAL

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Available Light 5700 Six Forks Road, Suite 203, Raleigh, NC 27609

SUSTAINABILITY

Frommact Consulting

Ecoimpact Consulting 8022 Providence Road Suite 500, Charlotte, NC 28277





Mann Hall Renovation
STATE ID #22-24500-02B
NCSU PROJECT # 202220021

NC STATE
INIVERSITY

North Carolina State
University

Facilities Division Design & Construction
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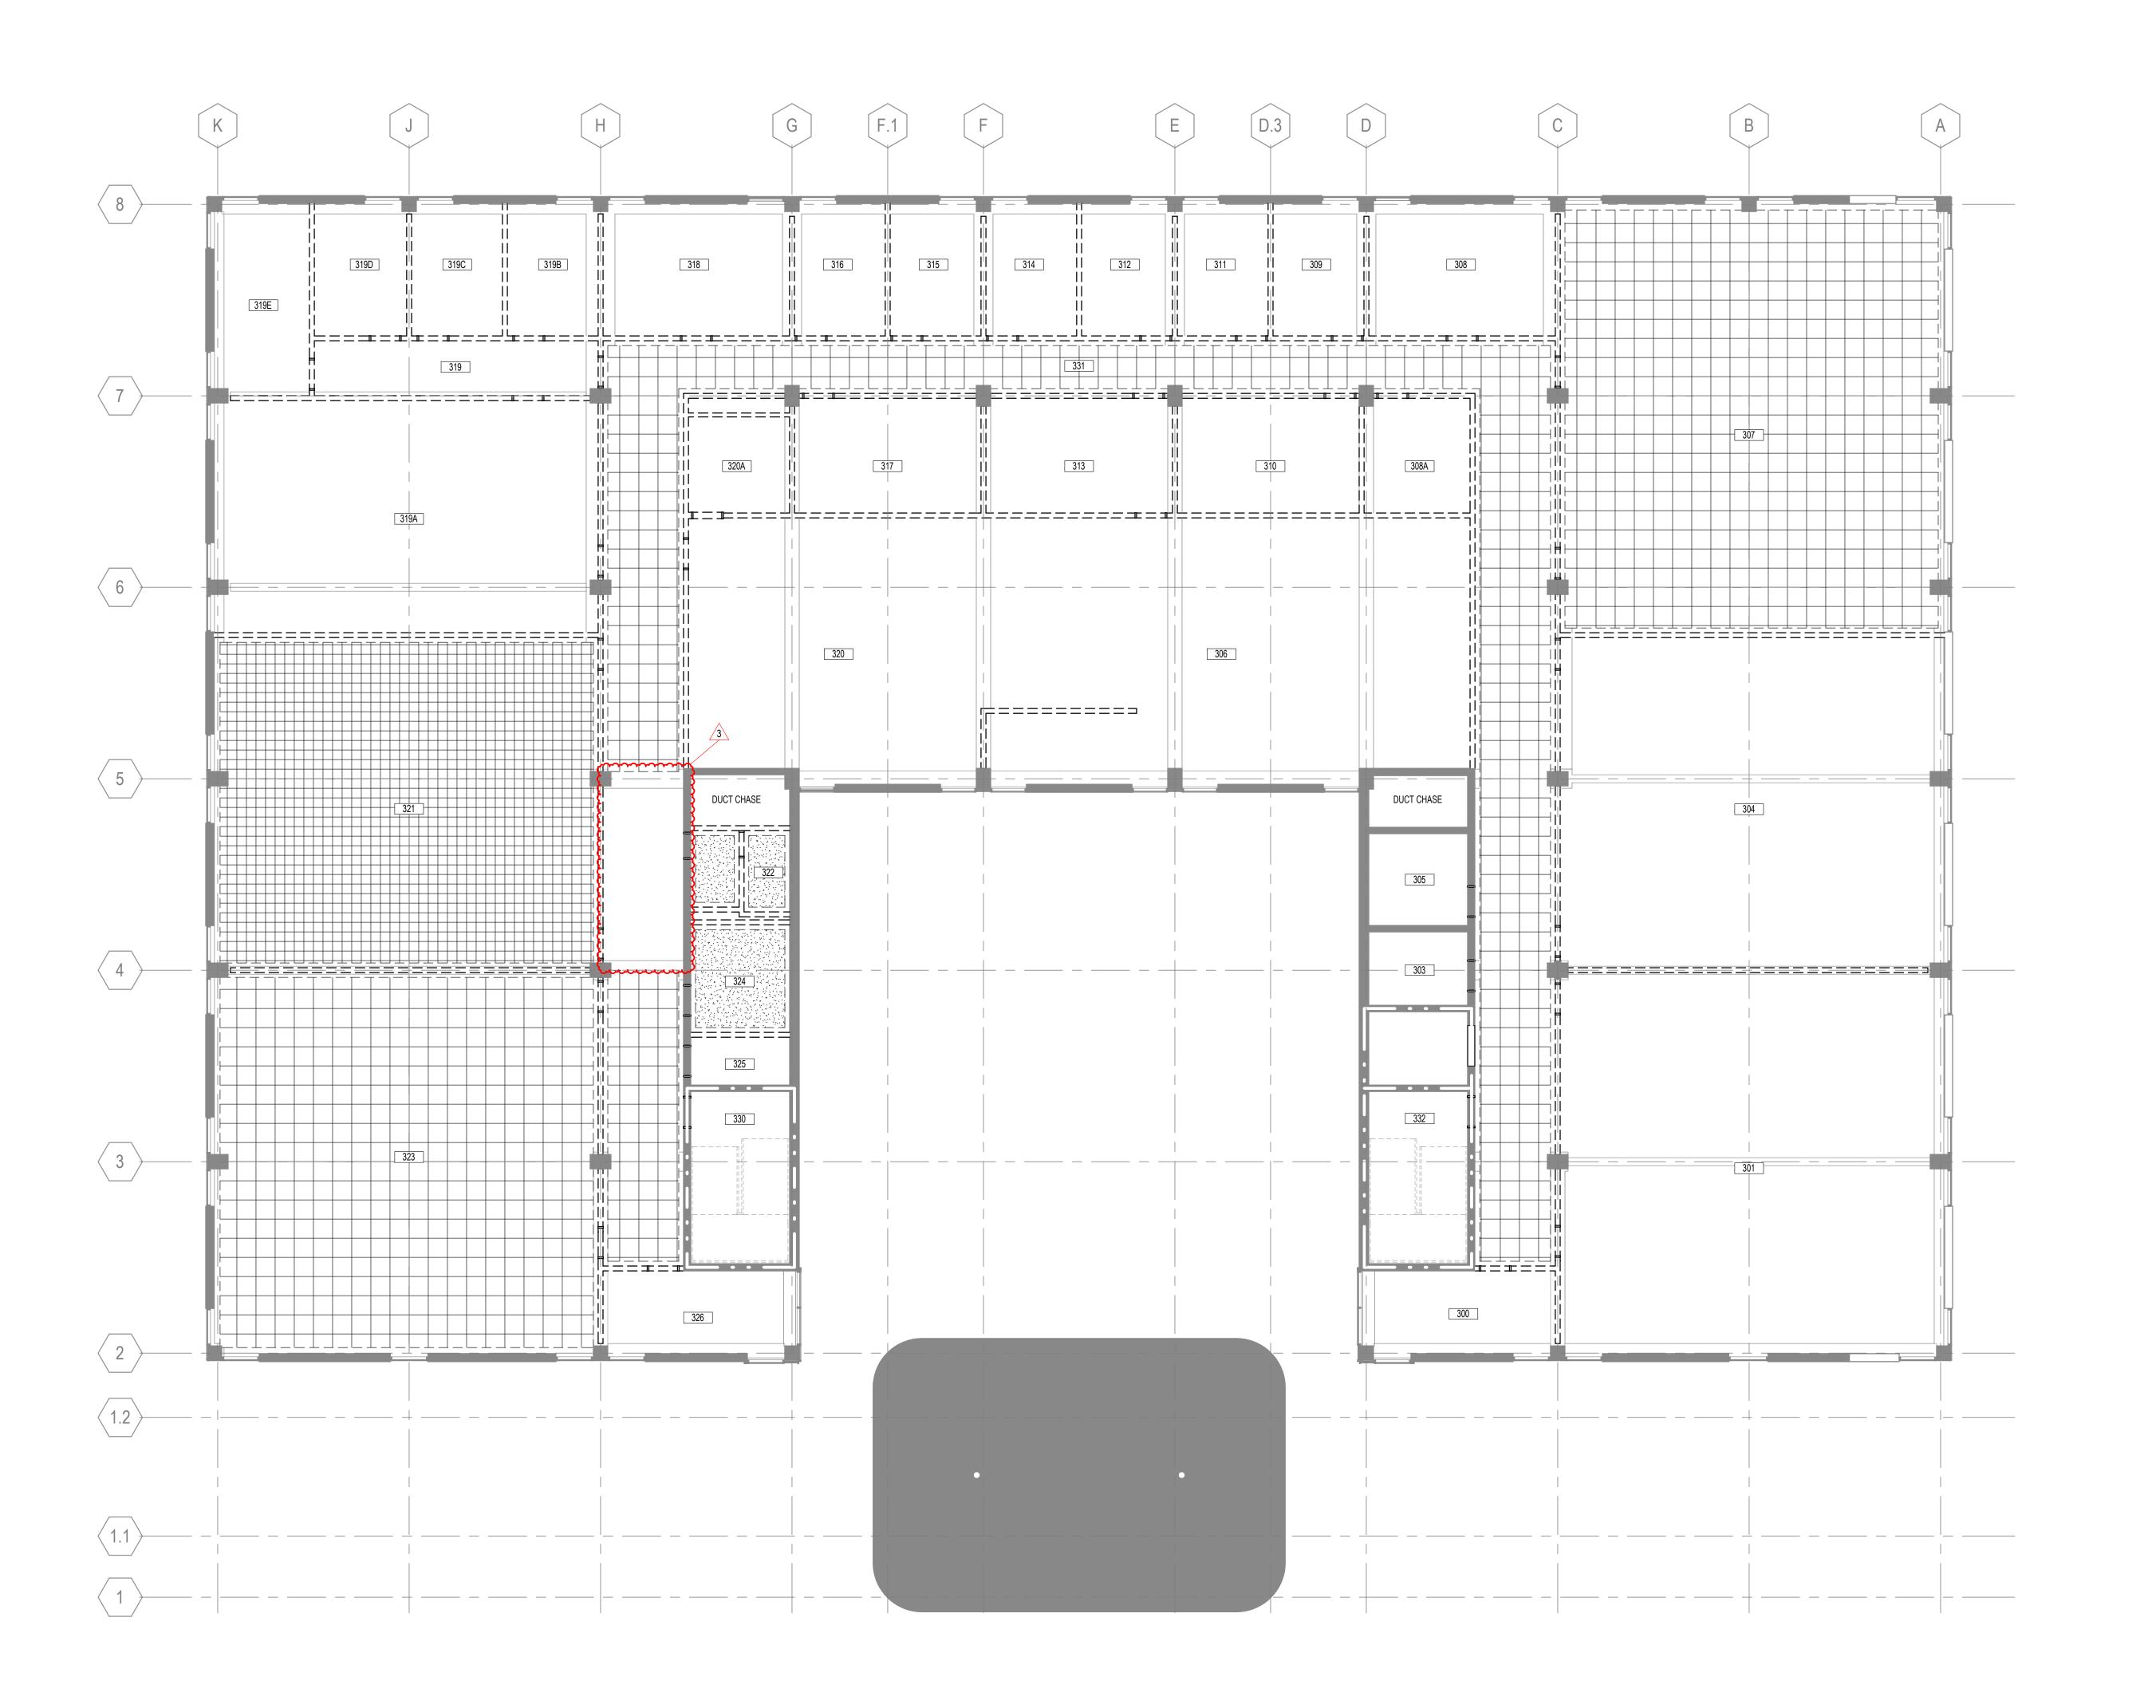


ISSUE CHART

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Job N	umber 8	20937.001
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1	ISSUE FOR BID - DEMO	4/17/2024
3	ISSUE FOR BID - DEMO REV 1	10/28/2024

DEMOLITION REFLECTED CEILING PLAN - FLOOR 02

SHEET NUMBER



NO SCOPE OUTSIDE OF THE BUILDING ENVELOPE HAS BEEN IDENTIFIED. WHEN SYSTEMS TO BE DEMOLISHED PENETRATE THE EXTERIOR ENVELOPE, TAKE CARE TO NOT DAMAGE ADJACENT SURFACES.

2. THESE DRAWINGS HAVE BEEN DEVELOPED FROM EXISTING DRAWINGS WHICH MAY NOT REFLECT ACTUAL FIELD CONDITIONS. VERIFY THESE DRAWINGS WITH EXISTING FIELD CONDITIONS AND NOTIFY THE ARCHITECT IMMEDIATELY OF INCONSISTENCIES BETWEEN THEM AND ACTUAL CONDITIONS BEFORE PROCEEDING WITH

REMOVE CONSTRUCTION AS INDICATED. TYPICAL WALL REMOVAL INCLUDES FINISHES AND MECHANICAL PLUMBING AND ELECTRICAL SYSTEMS CONTAINED THEREIN. REMOVE DOORS, CASEWORK, WINDOWS, FRAMES, AND OTHER FIXTURES AS REQUIRED. AFTER REMOVAL OF PIPE CHASES, PATCH HOLES IN FLOORS OR WALLS TO REMAIN TO MEET ORIGINAL FIRE PROTECTION AND STRUCTURAL REQUIREMENTS. PATCH ADJOINING WALLS, FLOORS AND DECK, AND PREPARE SURFACES TO RECEIVE

4. ASSUME NO SALVAGE / RELOCATION OF MATERIALS UNLESS NOTED OTHERWISE.

SEE MECHANICAL, PLUMBING, AND ELECTRICAL DRAWINGS FOR DEMOLITION OF UTILITIES.

SET FORTH BY ALL GOVERNING AUTHORITIES.

7. DO NOT PERFORM ANY STRUCTURAL WORK WITHOUT PRIOR APPROVAL FROM THE

DEMOLITION WORK SHALL BE EXECUTED IN CONFORMANCE WITH ALL CODES AND AS

STRUCTURAL ENGINEER.

8. THE BUILDING ENVELOPE SHALL BE MAINTAINED IN A WATER TIGHT CONDITION AT ALL TIMES. TEMPORARY PARTITIONS / PATCHES TO BE UTILIZED AS NEEDED UNTIL FINAL

CONSTRUCTION IS COMPLETED.

9. SCHEDULE ALL DEMOLITION WITH THE OWNER.

10. IN DEMOLITION REFLECTED CEILING PLANS, CONCRETE STRUCTURE TO REMAIN.

**DEMOLITION LEGEND** 

EXISTING CONSTRUCTION TO REMAIN

CONSTRUCTION TO BE REMOVED

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<<< Indicates Sheet Keynote on Plan</p>

**DEMOLITION NOTES BY NUMBER** 

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EXISTING 2-HR RATED CONSTRUCTION TO REMAIN

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SUSTAINABILITY

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NORTH CAPOLINE CORRESPONDENCE SOTES SOTES



Mann Hall Renovation

STATE ID #22-24500-02B

NCSU PROJECT # 202220021

NC STATE
JNIVERSITY

North Carolina State
University
Facilities Division Design & Construction
Administrative Services Building III
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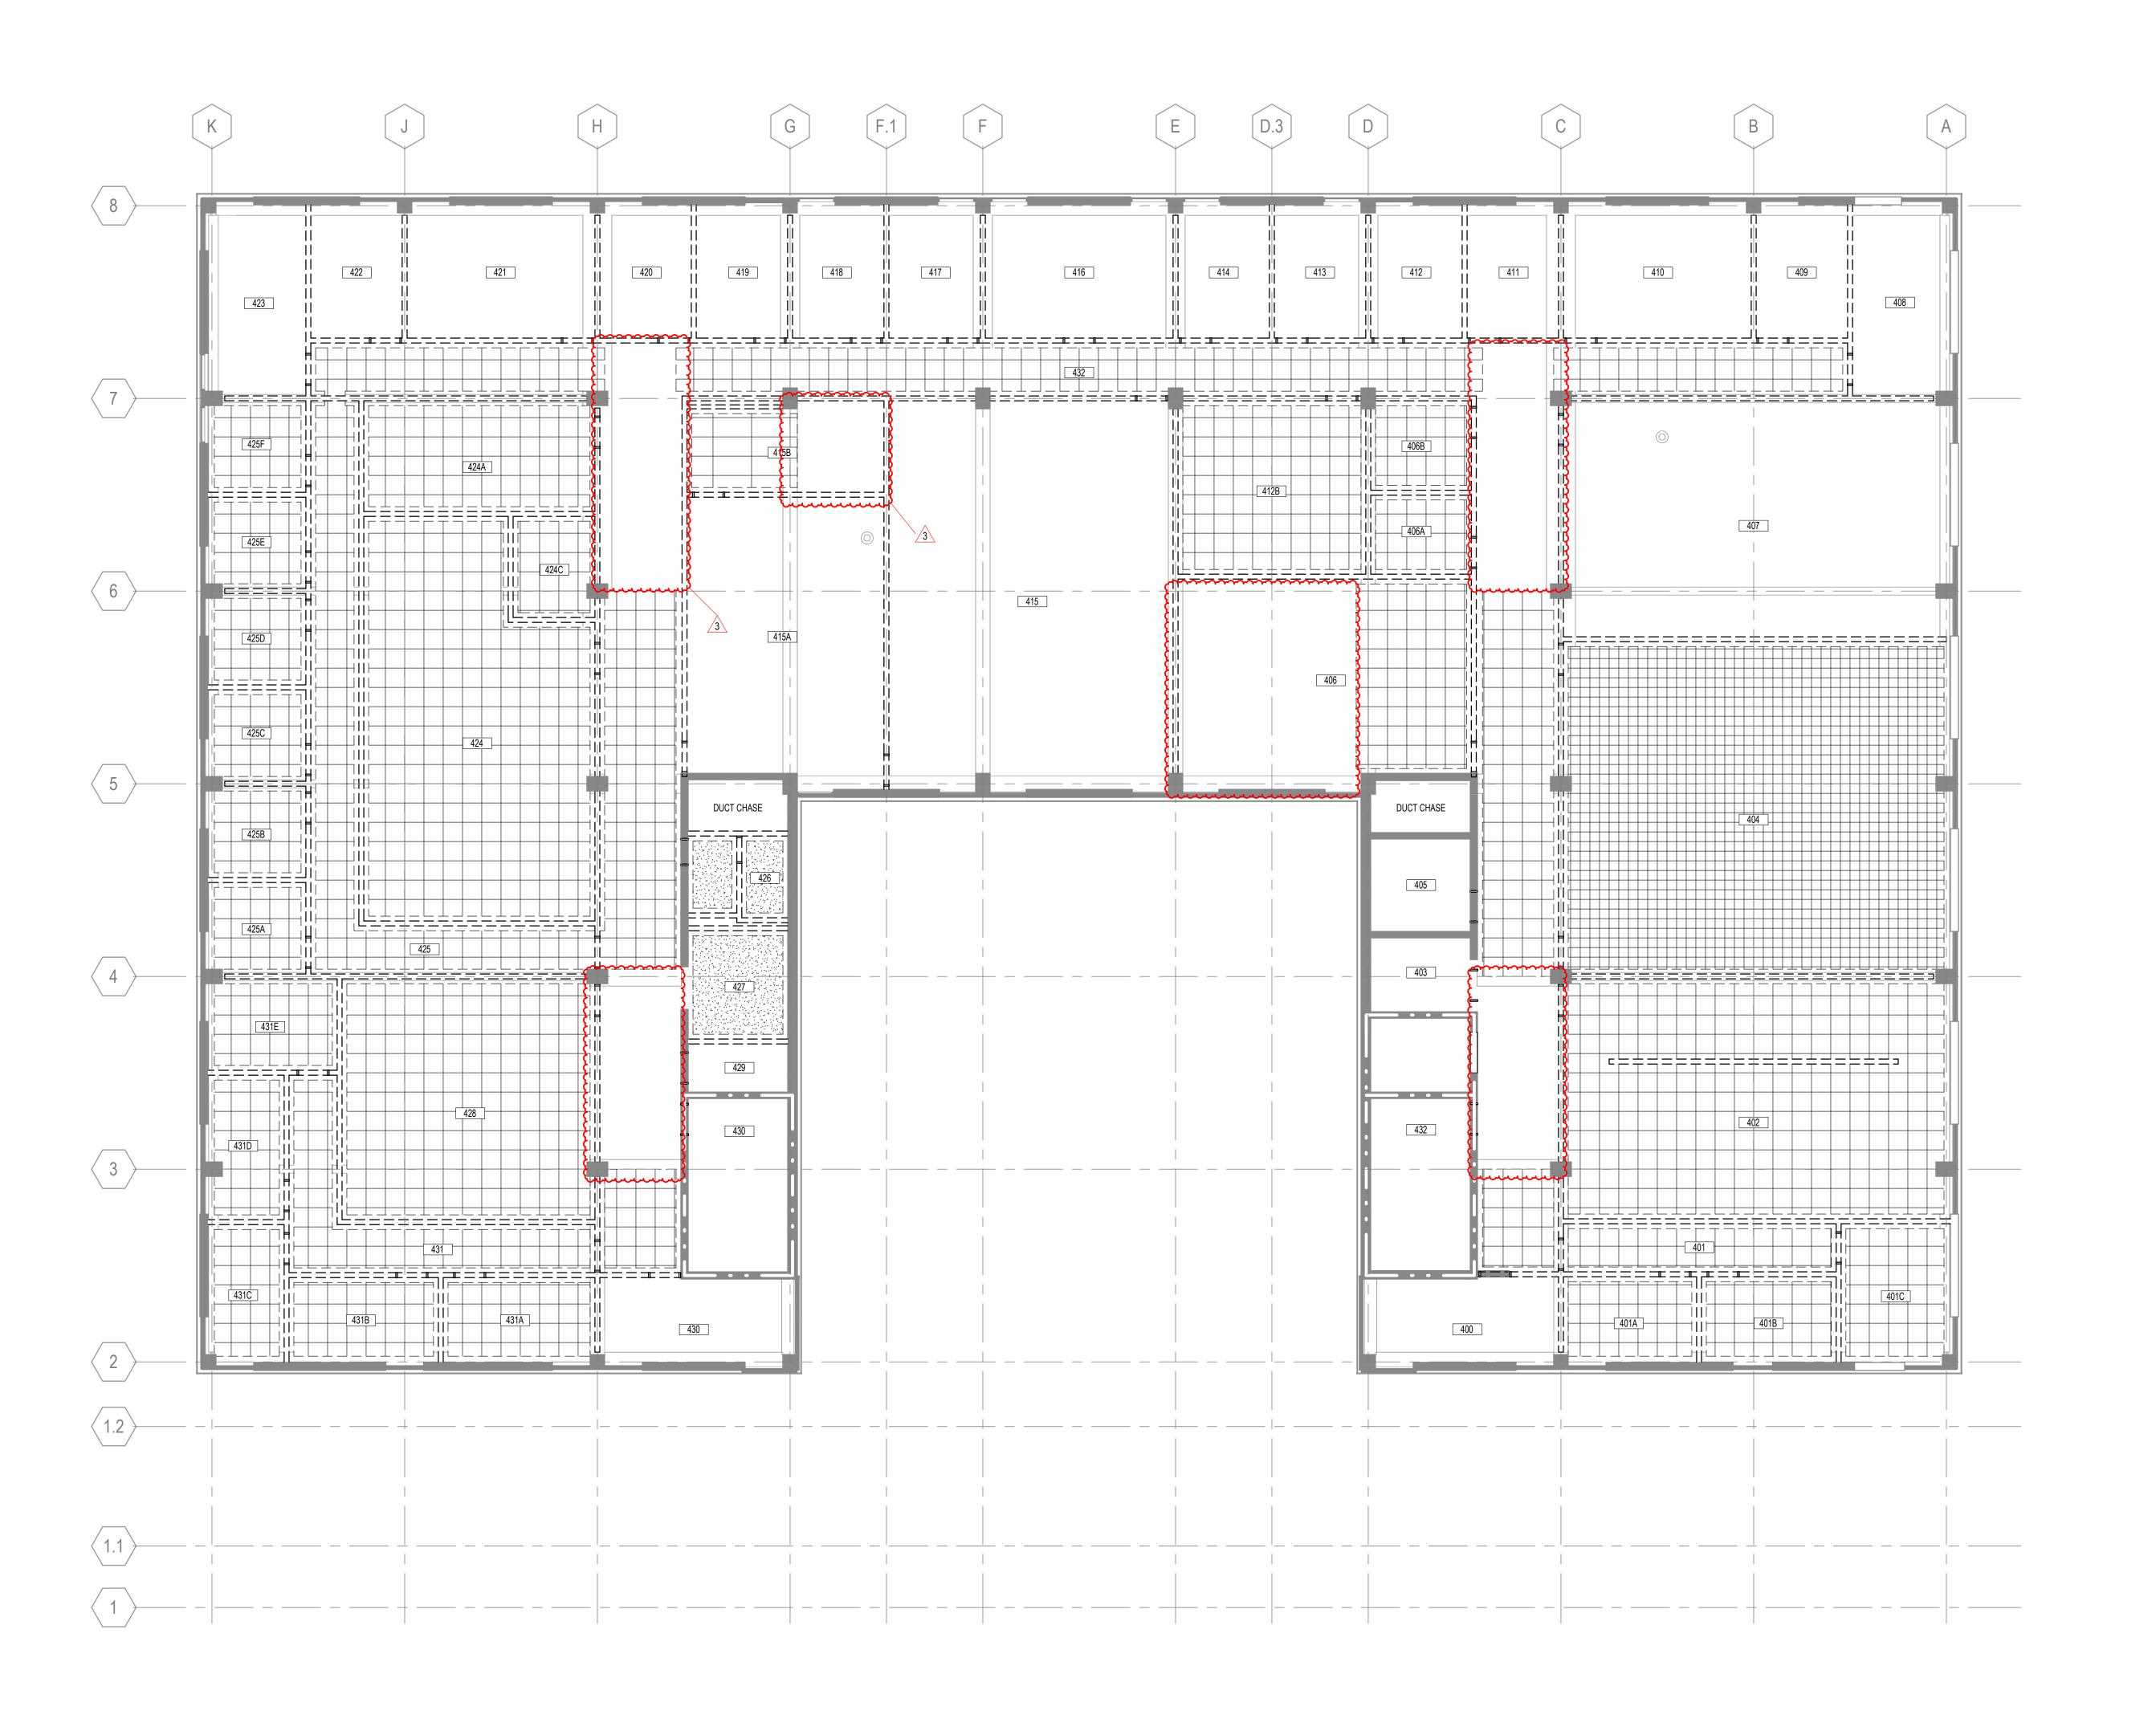


ISSUE CHART

DEMOLITION REFLECTED CEILING PLAN - FLOOR 03

SHEET NUMBER

TITLE



NO SCOPE OUTSIDE OF THE BUILDING ENVELOPE HAS BEEN IDENTIFIED. WHEN SYSTEMS TO BE DEMOLISHED PENETRATE THE EXTERIOR ENVELOPE, TAKE CARE TO NOT DAMAGE ADJACENT SURFACES.

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  PATCH ADJOINING WALLS, FLOORS AND DECK, AND PREPARE SURFACES TO RECEIVE NIEW EINISHES.
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- 10. IN DEMOLITION REFLECTED CEILING PLANS, CONCRETE STRUCTURE TO REMAIN.

**DEMOLITION LEGEND** 

EXISTING CONSTRUCTION TO REMAIN

CONSTRUCTION TO BE REMOVED

GYPSUM CEILING TO BE REMOVED.

STUCCO CEILING TO BE REMOVED.

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**DEMOLITION NOTES BY NUMBER** 

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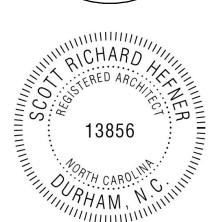
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Mann Hall Renovation

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NCSU PROJECT # 202220021



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ISSUE CHART

3	ISSUE FOR BID - DEMO REV 1	10/28/2024
1	ISSUE FOR BID - DEMO	4/17/2024
MARK	ISSUE	DATE
Job N	umber 8	20937.001
Orawr	1	Author
Check	red	Checker
Appro	ved	Approver

DEMOLITION REFLECTED CEILING PLAN - FLOOR 04

SHEET NUMBER